

BC Housing Nanaimo

1030 Old Victoria Road

Landscape Drawings - Issued for Development Permit

August 7, 2025

Civic Address

Property: 1030 Old Victoria Road, Nanaimo, B.C.

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Landscape Details
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Landscape Details



Context Plan

Issues		
No.	Description	Date
1	Preliminary Schematic Design	2024-12-20
2	Preliminary Schematic Design	2025-02-07
3	Issue for RZ	2025-03-14
4	Issue for 50% DD	2025-04-17
5	Issue for DD	2025-05-14
6	Issue for DD Review/ Resubmission	2025-07-30
7	Issue for Development Permit	2025-08-07

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Client: **BC Housing**

Project Title:
1030 Old Victoria Road,
Nanaimo, British Columbia

Drawing Title:
Landcape Context Plan

Project North:	Drawn By:	LR
	Checked By:	MP
Scale:	Job No.:	24-038
1:1000		
Sheet No.:		

Issues		
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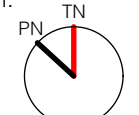
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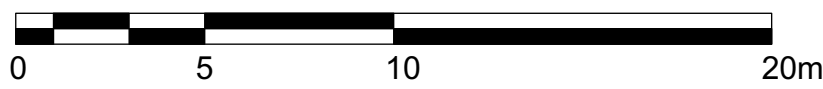
Client:
BC Housing

Project Title:
1030 Old Victoria Road,
Nanaimo, British Columbia

Drawing Title:
Landscape Concept Plan

Project North:	Drawn By:
	LR
	Checked By:
	MP
Scale:	Job No.:
1:200	24-038
Sheet No.:	

LINE TYPE LEGEND	FENCE LEGEND	MATERIAL LEGEND	
<div><div></div>PROPERTY LINE</div>	<div><div></div>4' HT FENCE</div>	<div><div></div>CIP CONCRETE PAVING</div>	<div><div></div>DECIDUOUS TREE</div>
<div><div></div>SRW</div>	<div><div></div>6' HT FENCE</div>	<div><div></div>ASPHALT</div>	<div><div></div>CONIFEROUS TREE</div>
<div><div></div>SUBDIVISION LINE</div>	<div><div></div>EXISTING CHAIN LINK FENCE</div>	<div><div></div>GRAVEL</div>	<div><div></div>BENCH</div>
<div><div></div>OVERHEAD LINE</div>		<div><div></div>SHRUB PLANTING</div>	
		<div><div></div>FLEX USE LAWN</div>	



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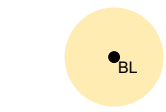
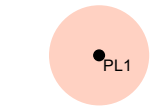




Drawing Title:
Landscape Key Plan

Project North:	Drawn By:
	LR
	Checked By:
	MP
Scale:	Job No.:
1:200	24-038
Sheet No.:	

L1.1



LIGHTING LEGEND:

-  Bollard Light
-  Post-Top Light 1
-  Post-Top Light 2
-  Building Lighting, Refer To Architectural and Electrical, Shown for Reference Only
-  Uplight
-  Receptacle Location (GFCI In Exterior Grade Box)

Notes:
- Lighting plan for illustrative purposes only and to be read in conjunction with Architectural and Electrical lighting plans.
- Refer to Architectural for all soffit lighting.

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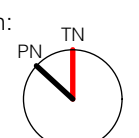
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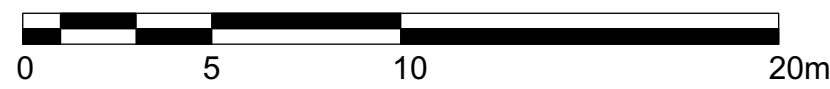
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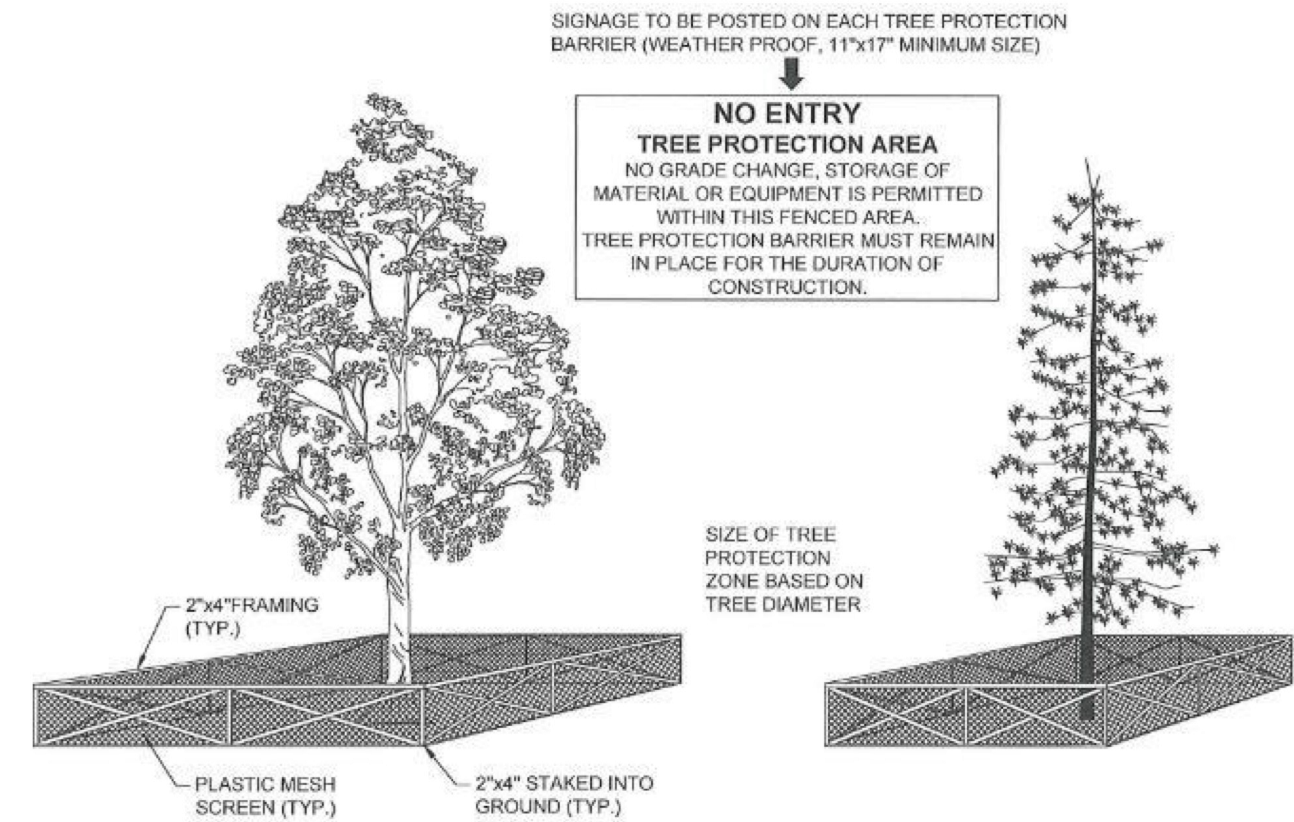
Drawing Title:
Lighting Plan

Project North:  Drawn By: **LR**
Checked By: **MP**
Scale: **1:200** Job No.: **24-038**
Sheet No.:




MINIMUM PROTECTION REQUIRED AROUND TREE			
Trunk Diameter (cm)	Distance from Trunk (m)	Trunk Diameter (cm)	Distance from Trunk (m)
20	1.2	50	3.0
25	1.5	55	3.3
30	1.8	60	3.6
35	2.1	75	4.5
40	2.4	90	5.0
45	2.7	100	6.0

* Table adapted from Vancouver Island Tree Service Ltd. Arborist Report



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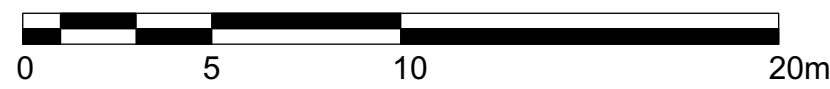
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Project Title:
1030 Old Victoria Road,
Nanaimo, British Columbia

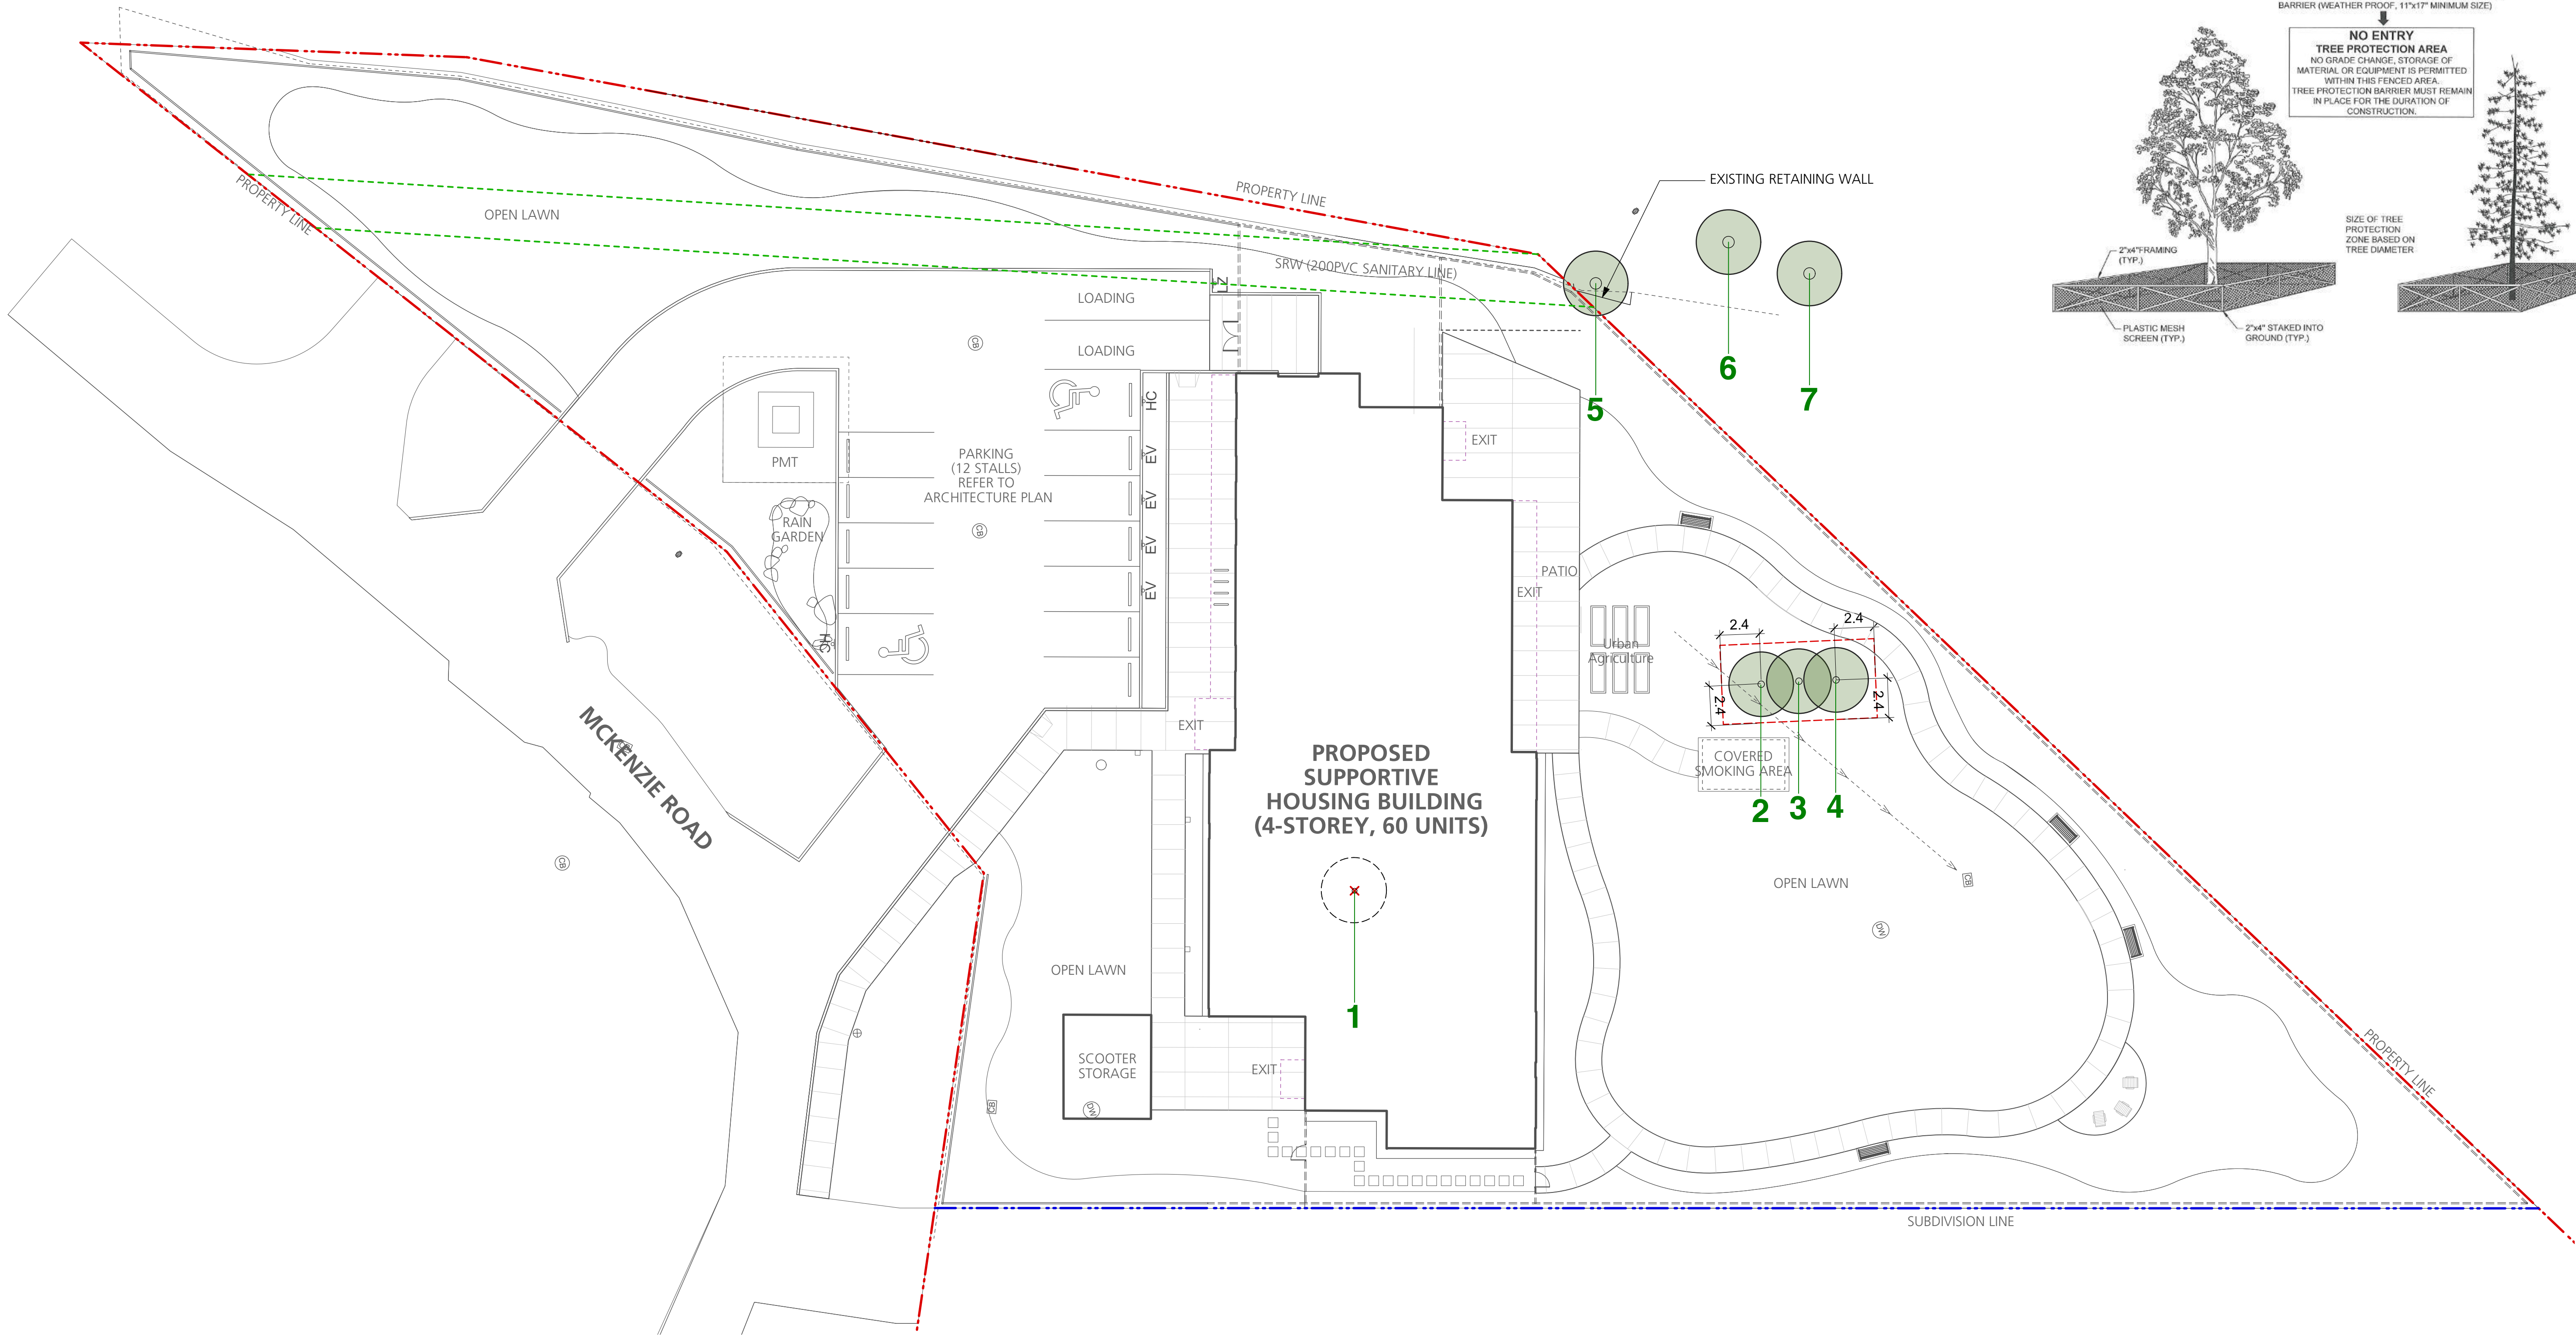Drawing Title:
**Preliminary Tree
Inventory Plan**

Project North:	Drawn By:
	LR
	Checked By:
	MP
Scale:	Job No.:
1:200	24-038
Sheet No.:	



TREE INVENTORY TABLE								
Trunk	Common Name	Species	DBH (cm)	Height (m)	Critical Root Zone radius (m)	Overall Condition Rating	Status	Replacement Trees
1	Douglas Fir	<i>Pseudotsuga menziesii</i>	60 combined (30+30)	9	3.6	Good	Remove	6*
2	Douglas Fir	<i>Pseudotsuga menziesii</i>	40	10	2.4	Good	Retain	
3	Douglas Fir	<i>Pseudotsuga menziesii</i>	40	10	2.4	Good	Retain	
4	Douglas Fir	<i>Pseudotsuga menziesii</i>	40	10	2.4	Good	Retain	
5	Douglas Fir	<i>Pseudotsuga menziesii</i>	70	15	4.2	Good	Retain	
6	Douglas Fir	<i>Pseudotsuga menziesii</i>	70	15	4.2	Good	Retain	
7	Douglas Fir	<i>Pseudotsuga menziesii</i>	70	15	4.2	Good	Retain	

* Adapted from management and protection of trees bylaw 2013 No. 7126, Schedule G

EXISTING TREES LEGEND

Tree To be removed:

Tree To be retained and protected:

Tree Tag No.
Refer to Arborist Report for Tree Protection Fence and Protection Zone

Note:
Existing trees to be removed per arborist report.

- GENERAL NOTES
1. This plan is to be read in conjunction with Arborist Report. Refer to arborist report by Davey Resource Group, arborist Riley Hannigan, March 13, 2025.

2. Any work within the tree protection areas must be under supervision of the consulting arborist for the project.

3. Proposed street trees species, sizes and location to be coordinated with the City of Nanaimo.

4. Trees must be adequately watered during the entire construction process. Any roots exposed from lines of excavation must be covered with burlap and poly plastic in an effort to prevent desiccation of exposed roots. Absolutely no grade changes are to occur within the Critical Root Zones of retained trees.

5. Construction materials are not to be stored within the Tree Protection Zones (TPZ) of trees to be retained, and TPZ fencing is to remain intact for the entire construction process. Signage must be clearly posted on each side of the barrier indicating "TREE PROTECTION ZONE - DO NOT ENTER OR MODIFY". TPZ is to be modified by the site Arborist only; contact your project Arborist for any TPZ barrier issues. All workers must be notified of the Tree Protection Zones, and that entry into these zones is not permitted.

6. Trenching for utility connections to be coordinated with Engineering Department to ensure safe root zones of retained trees. Methods of tree protection for street trees to be approved by City of Nanaimo.

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Client:
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Drawing Title:
Planting Plan

Project North:	Drawn By:
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	Checked By:
	MP
Scale:	Job No.:
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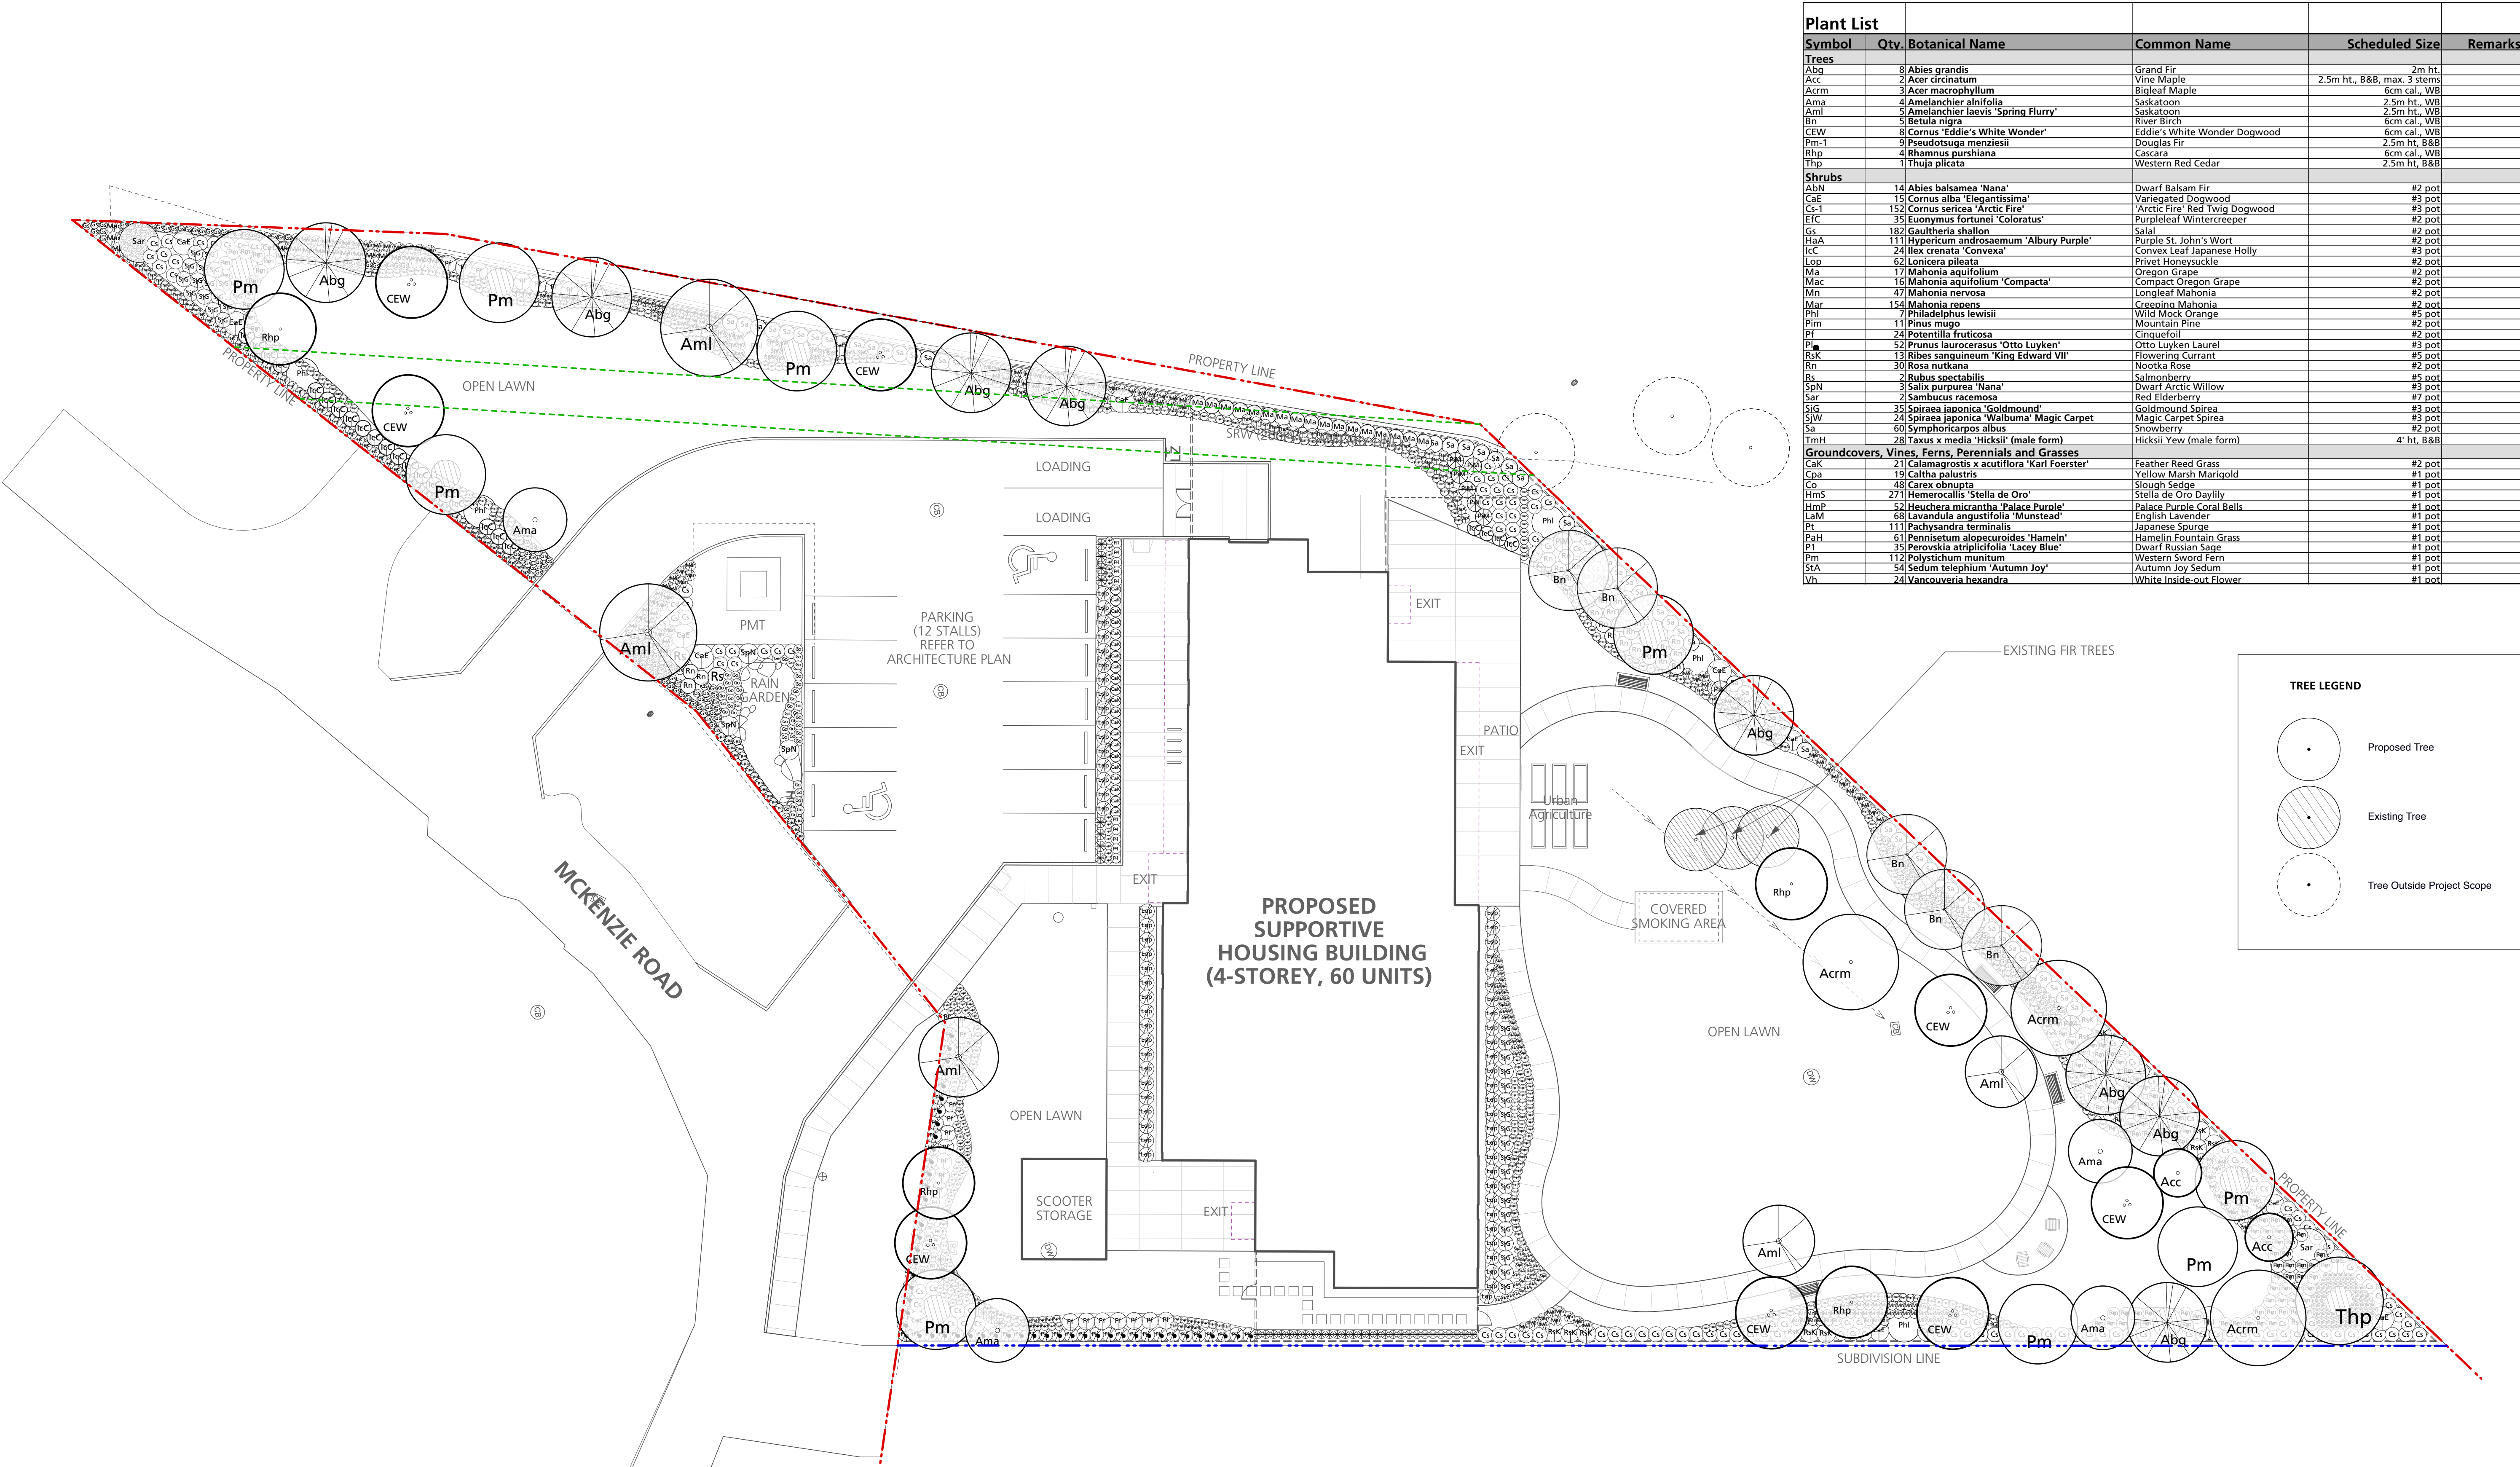
Symbol	Qty.	Botanical Name	Common Name	Scheduled Size	Remarks
Trees					
Abg	8	Abies grandis	Grand Fir	2m ht.	
Acc	2	Acer circinatum	Vine Maple	2.5m ht., B&B, max. 3 stems	
Acrm	3	Acer macrophyllum	Bigleaf Maple	6cm cal., WB	
Ama	4	Amelanchier alnifolia	Saskatoon	2.5m ht., WB	
Aml	5	Amelanchier laevis 'Spring Flurry'	Saskatoon	2.5m ht., WB	
Bn	5	Betula nigra	River Birch	6cm cal., WB	
CEW	8	Cornus 'Eddie's White Wonder'	Eddie's White Wonder Dogwood	6cm cal., WB	
Ph-1	9	Pseudotsuga menziesii	Douglas Fir	2.5m ht., B&B	
Rhp	4	Rhamnus purshiana	Cascara	6cm cal., WB	
Thp	1	Thuja plicata	Western Red Cedar	2.5m ht., B&B	
Shrubs					
ABN	14	Abies balsamea 'Nana'	Dwarf Balsam Fir	#2 pot	
CaE	15	Cornus alba 'Elegantissima'	Variegated Dogwood	#3 pot	
Ca-1	152	Cornus sericea 'Arctic Fire'	'Arctic Fire' Red Twig Dogwood	#3 pot	
EFIC	35	Euonymus fortunei 'Coloratus'	Purpleleaf Wintercreeper	#2 pot	
Gs	182	Gaultheria shallon	Salal	#2 pot	
HaA	111	Hypericum androsaemum 'Albury Purple'	Purple St. John's Wort	#2 pot	
ICC	24	Ilex crenata 'Convexa'	Convex Leaf Japanese Holly	#3 pot	
Lop	62	Lonicera pileata	Privet Honeysuckle	#2 pot	
Ma	17	Mahonia aquifolium	Oregon Grape	#2 pot	
Mac	16	Mahonia aquifolium 'Compacta'	Compact Oregon Grape	#2 pot	
Mn	47	Mahonia nervosa	Longleaf Mahonia	#2 pot	
Mar	154	Mahonia repens	Creeching Mahonia	#2 pot	
Phl	7	Philadelphus lewisii	Wild Mock Orange	#5 pot	
Pim	11	Pinus mugo	Mountain Pine	#2 pot	
Pf	24	Potentilla fruticosa	Cinquefoil	#2 pot	
Pl	52	Prunus laurocerasus 'Otto Luyken'	Otto Luyken Laurel	#3 pot	
RaK	13	Ribes sanguineum 'King Edward VII'	Flowering Currant	#5 pot	
Rn	30	Rosa nutkana	Nootka Rose	#2 pot	
Rs	2	Rubus spectabilis	Salmonberry	#5 pot	
SpN	3	Salix purpurea 'Nana'	Dwarf Arctic Willow	#3 pot	
Sar	2	Sambucus racemosa	Red Elderberry	#7 pot	
SIG	35	Spiraea japonica 'Goldmound'	Goldmound Spirea	#3 pot	
SiW	24	Spiraea japonica 'Walburna' Magic Carpet	Magic Carpet Spirea	#3 pot	
Sa	60	Symphoricarpos albus	Snowberry	#2 pot	
TmH	28	Taxus x media 'Hicksii' (male form)	Hicksii Yew (male form)	4' ht., B&B	
Groundcovers, Vines, Ferns, Perennials and Grasses					
CaK	21	Calamagrostis x acutiflora 'Karl Foerster'	Feather Reed Grass	#2 pot	
CaK	19	Caltha palustris	Yellow Marsh Marigold	#1 pot	
Co	48	Carex obnupta	Slough Sedge	#1 pot	
HmS	271	Hemerocallis 'Stella de Oro'	Stella de Oro Daylily	#1 pot	
HmP	52	Heuchera micrantha 'Palace Purple'	Palace Purple Coral Bells	#1 pot	
LaM	68	Lavandula angustifolia 'Munstead'	English Lavender	#1 pot	
Pl	111	Pachysandra terminalis	Japanese Spurge	#1 pot	
PaH	61	Pennisetum alopecuroides 'Hameln'	Hameln Fountain Grass	#1 pot	
Pi	35	Perovskia atriplicifolia 'Lacey Blue'	Dwarf Russian Sage	#1 pot	
Pm	112	Polystichum munitum	Western Sword Fern	#1 pot	
SEA	54	Sedum telephium 'Autumn Joy'	Autumn Joy Sedum	#1 pot	
Vh	24	Vancouveria hexandra	White Inside-out Flower	#1 pot	

TREE LEGEND

Proposed Tree

Existing Tree

Tree Outside Project Scope



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Client:
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Project Title:
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Drawing Title:
Preliminary Irrigation Plan


Project North:	Drawn By:
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Scale:	Job No.:
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IRRIGATION LEGEND


AREAS TO BE IRRIGATED

GENERAL NOTES:



1. THE IRRIGATION CONTRACTOR TO PROVIDE A DESIGN BUILD IRRIGATION SYSTEM TO MEET 50% POTABLE WATER REDUCTION. CONTRACTOR TO PROVIDE SHOP DRAWINGS FOR CONSULTANT REVIEW AND APPROVAL.
2. THE IRRIGATION SYSTEM SHALL BE DESIGNED AND INSTALLED AS PER THE IRRIGATION INDUSTRY ASSOCIATION OF BC (IIABC) STANDARDS OR BETTER. THE APPROVED SYSTEM SHALL BE DESIGNED AND INSTALLED BY IIABC CERTIFIED PROFESSIONAL.
3. THE IRRIGATION PLAN SHALL BE READ IN CONJUNCTION WITH LANDSCAPE DRAWINGS BY PERRY AND ASSOCIATES.
4. NO IRRIGATION PIPING IS PERMITTED IN THE EXISTING TREE ROOT PROTECTION ZONE AS INDICATED ON TREE MANAGEMENT PLAN AND ARBORIST REPORT.
5. IRRIGATION CONTRACTOR TO COORDINATE WITH GENERAL CONTRACTOR TO ENSURE ALL IRRIGATION SLEEVES ARE PLACED PRIOR TO PLACEMENT OF HARD SURFACES.
6. ALL NEW TREES ARE TO BE IRRIGATED AS PART OF THE IRRIGATION SYSTEM.
7. IRRIGATION CONTRACTOR TO CONFIRM SUFFICIENT PRESSURE AT MAIN WATER CONNECTION AND ALL STUBOUT LOCATIONS. SET OPERATING PRESSURE TO MANUFACTURER RECOMMENDED RANGE TO ENSURE OPTIMAL COVERAGE. ADJUST IRRIGATION SYSTEM AS REQUIRED TO SUIT AVAILABLE PRESSURE AS REQUIRED.
8. THE GENERAL CONTRACTOR TO COORDINATE WITH ELECTRICAL CONSULTANT AND CONTRACTOR TO SUPPLY POWER FOR THE CONTROLLER LOCATIONS AS INDICATED ON APPROVED SHOP DRAWINGS.
9. THE IRRIGATION CONTRACTOR SHALL INSTALL THE CONTROLLER AND RUN ALL THE LOW VOLTAGE WIRES FROM THE CONTROLLER TO THE SOLENOID VALVES LOCATIONS PER APPROVED SHOP DRAWINGS.
10. RAINBIRD WR2-RFC WIRELESS RAIN/FREEZE SENSOR (OR APPROVED EQUIVALENT) TO BE INCLUDED THIS CONTRACT. IRRIGATION CONTRACTOR SHALL COORDINATE LOCATION WITH GENERAL CONTRACTOR AND LANDSCAPE ARCHITECT AND CONNECT SENSOR TO THE CONTROLLER.
11. ALL NEW TREES TO BE PLANTED PER PLANTING PLAN TO BE PROVIDED AUTOMATIC IRRIGATION AS PER APPROVED SHOP DRAWINGS.
12. WHERE MATERIALS ARE SPECIFIED BY BRAND NAME AND MODEL NUMBERS, SUBSTITUTIONS WILL NOT BE PERMITTED UNLESS SUBMITTED FOR PRIOR APPROVAL TO PERRY AND ASSOCIATES LANDSCAPE ARCHITECTS.
13. CONTRACTOR IS RESPONSIBLE FOR VERIFYING LOCATION OF AND PROTECTING ANY BELOW GROUND UTILITIES FROM DAMAGE DUE TO IRRIGATION WORK.
14. CONTRACTOR TO PROVIDE IRRIGATION AS-BUILT DRAWINGS POST CONSTRUCTION TO SHOW INSTALLED LOCATIONS OF RAIN SENSOR, VALVE BOXES, SLEEVES AND IRRIGATION HEADS. CONTRACTOR TO PROGEAM IRRIGATION CONTROLLER AND ANNOTATE ALL IRRIGATION ZONES IN CONTROLLER CABINET. CONTRACTOR TO SUPPLY MANUALS AND TOOLS REQUIRED FOR SYSTEM OPERATION TO THE OWNER UPON SYSTEM COMPLETION. CONTRACTOR TO PROVIDE AS BUILT PLAN AT COMPLETION OF PROJECT.
15. FLOW RATES ON SYSTEM NEVER TO EXCEED 5' PER SECOND.

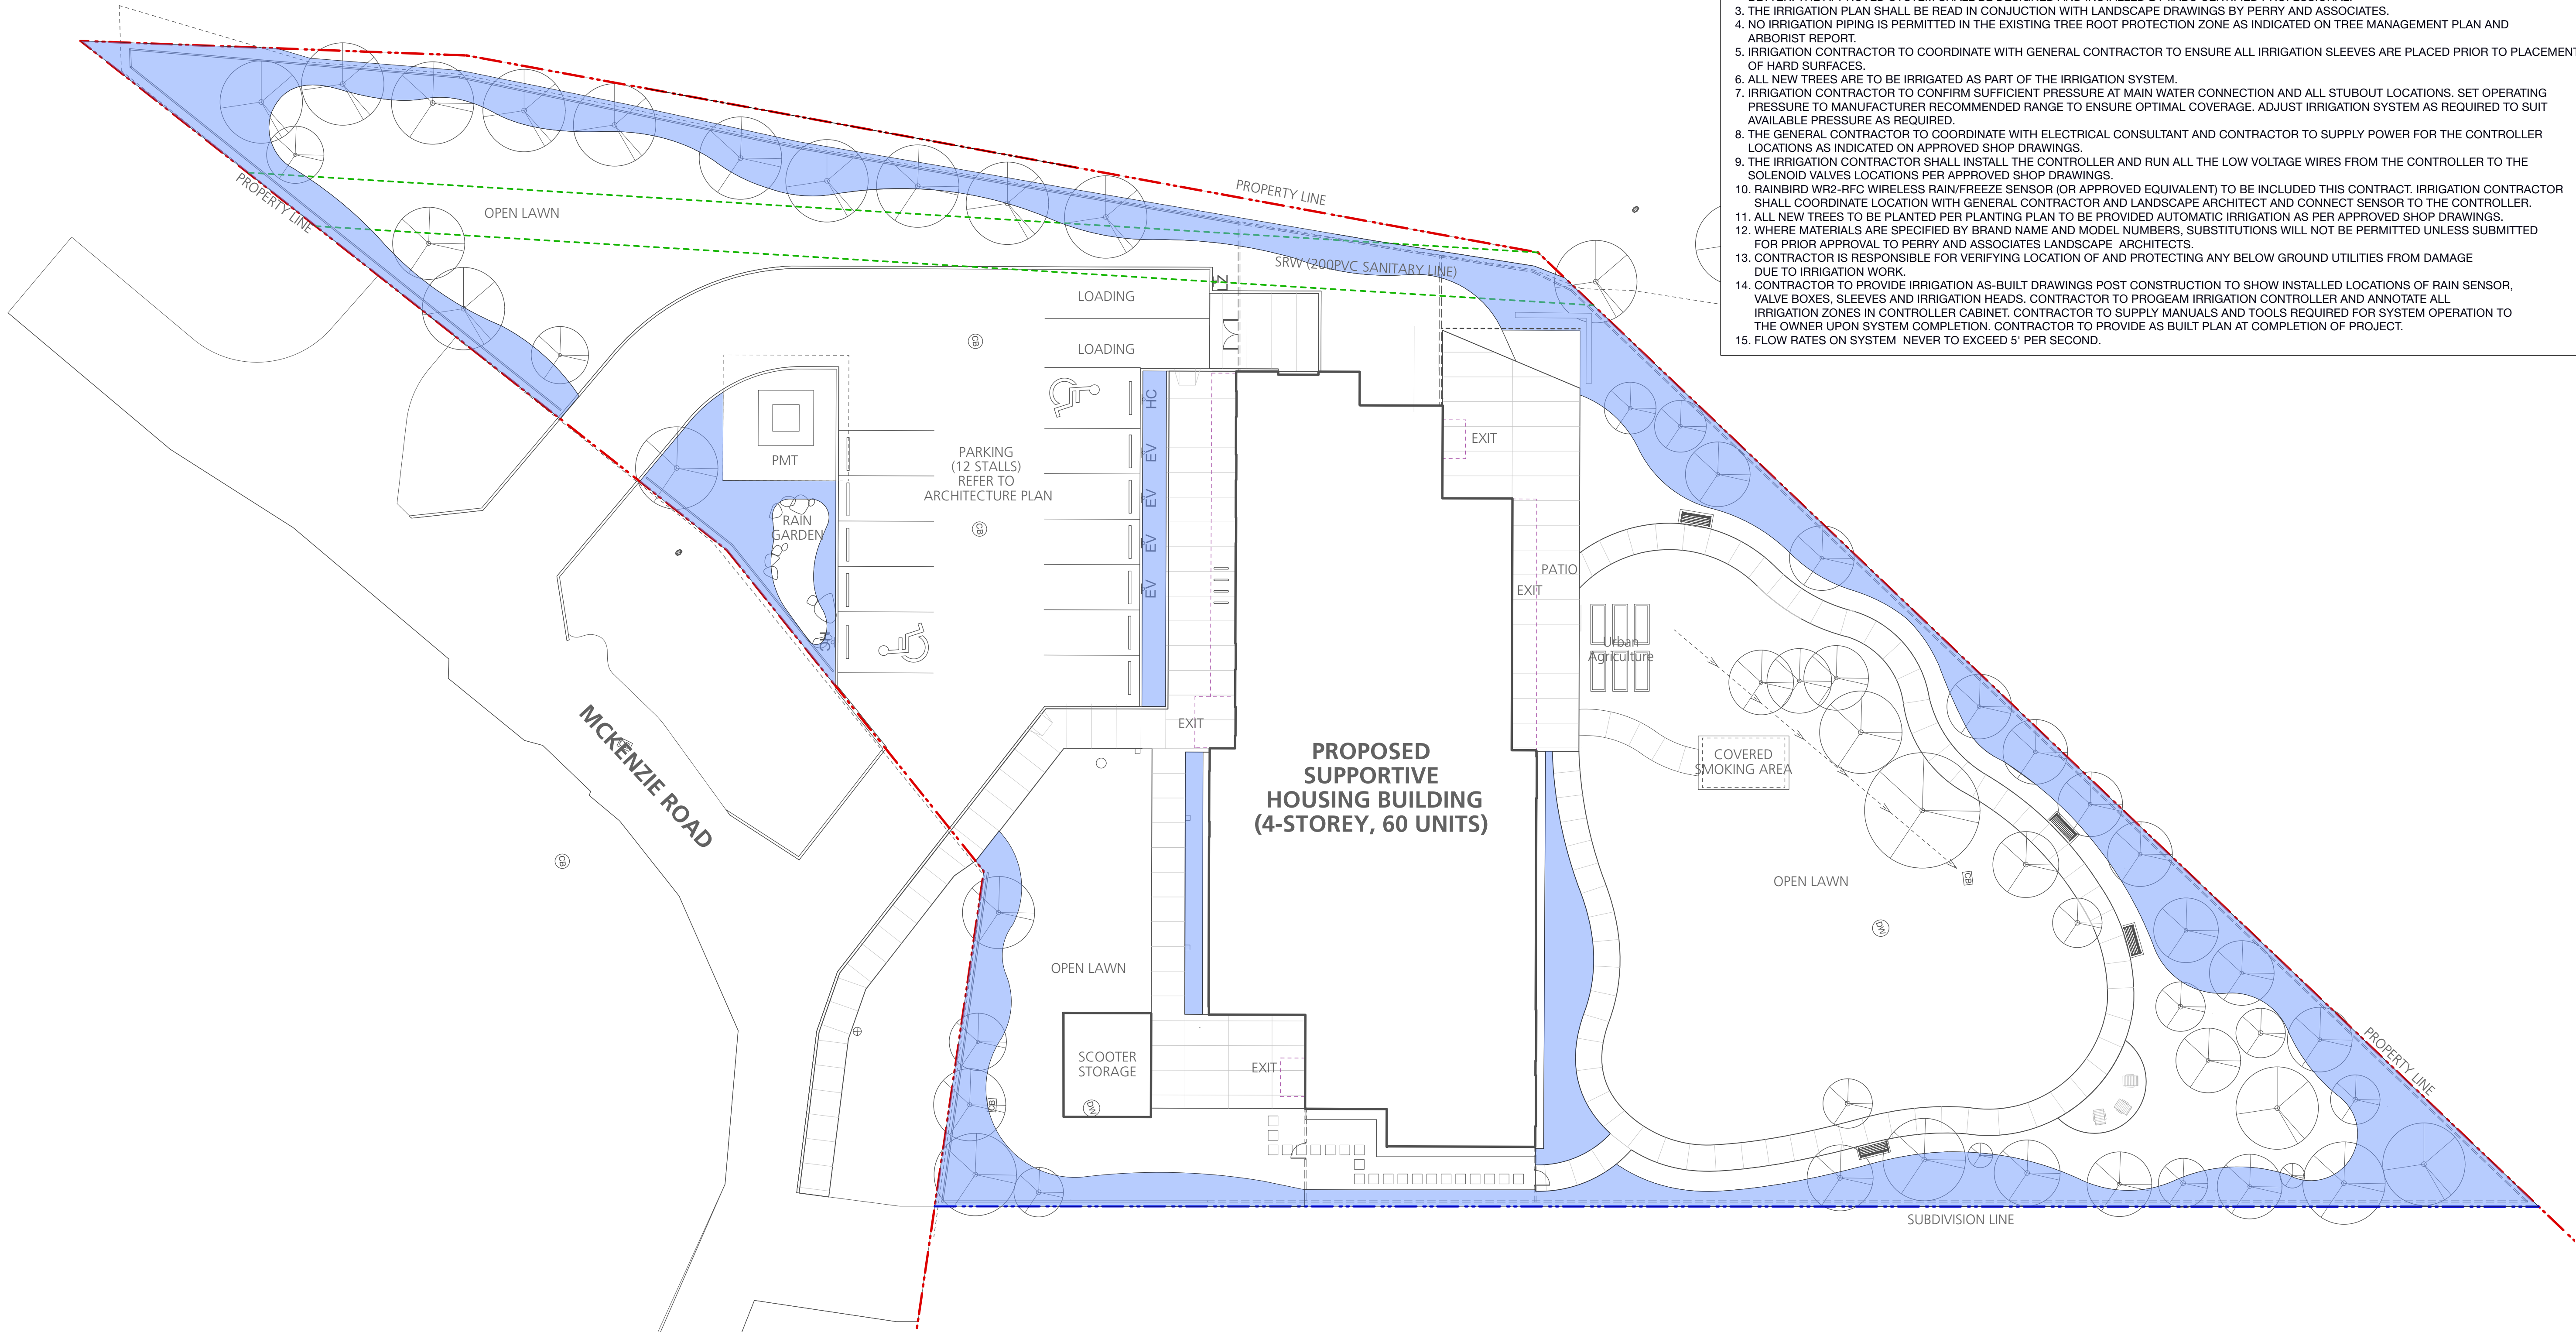


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SECTION KEY PLAN | 1:1000

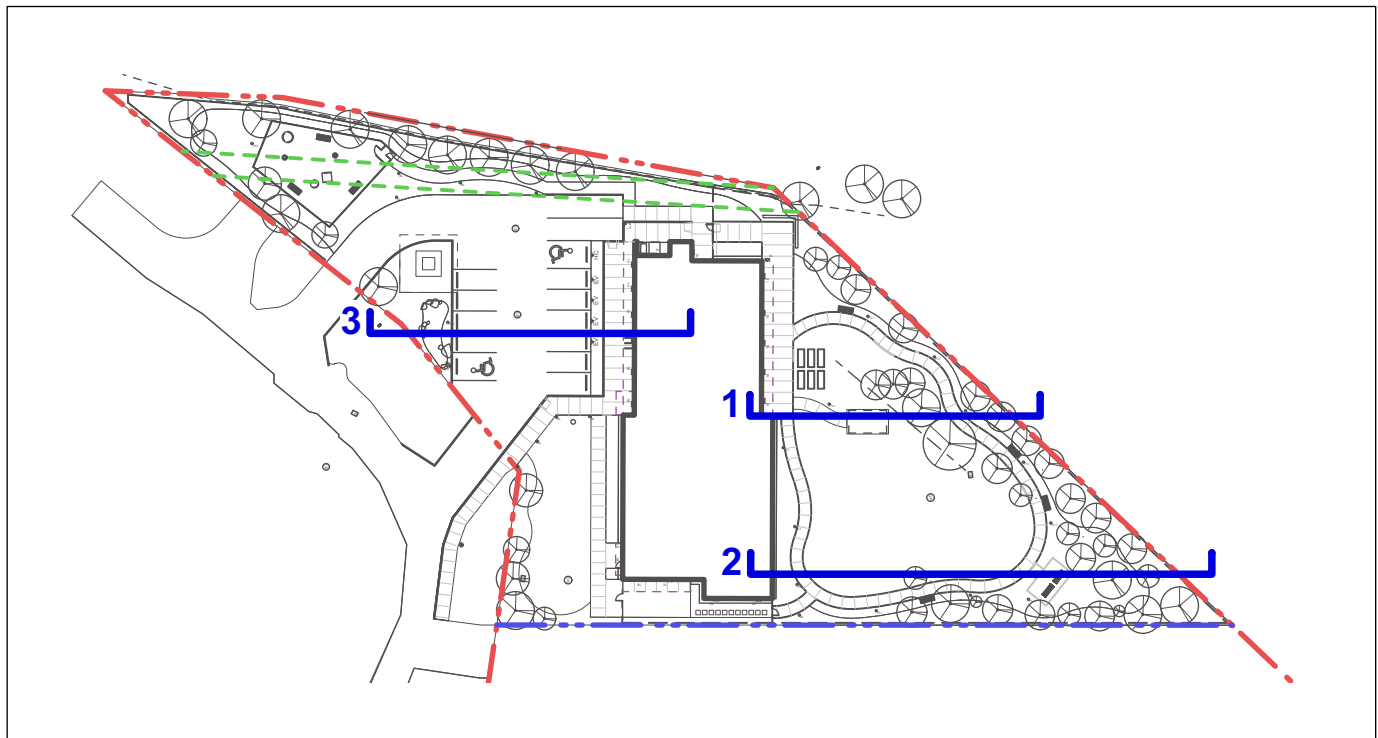

1 South of Building Patio to Property Line
Scale: 1:100

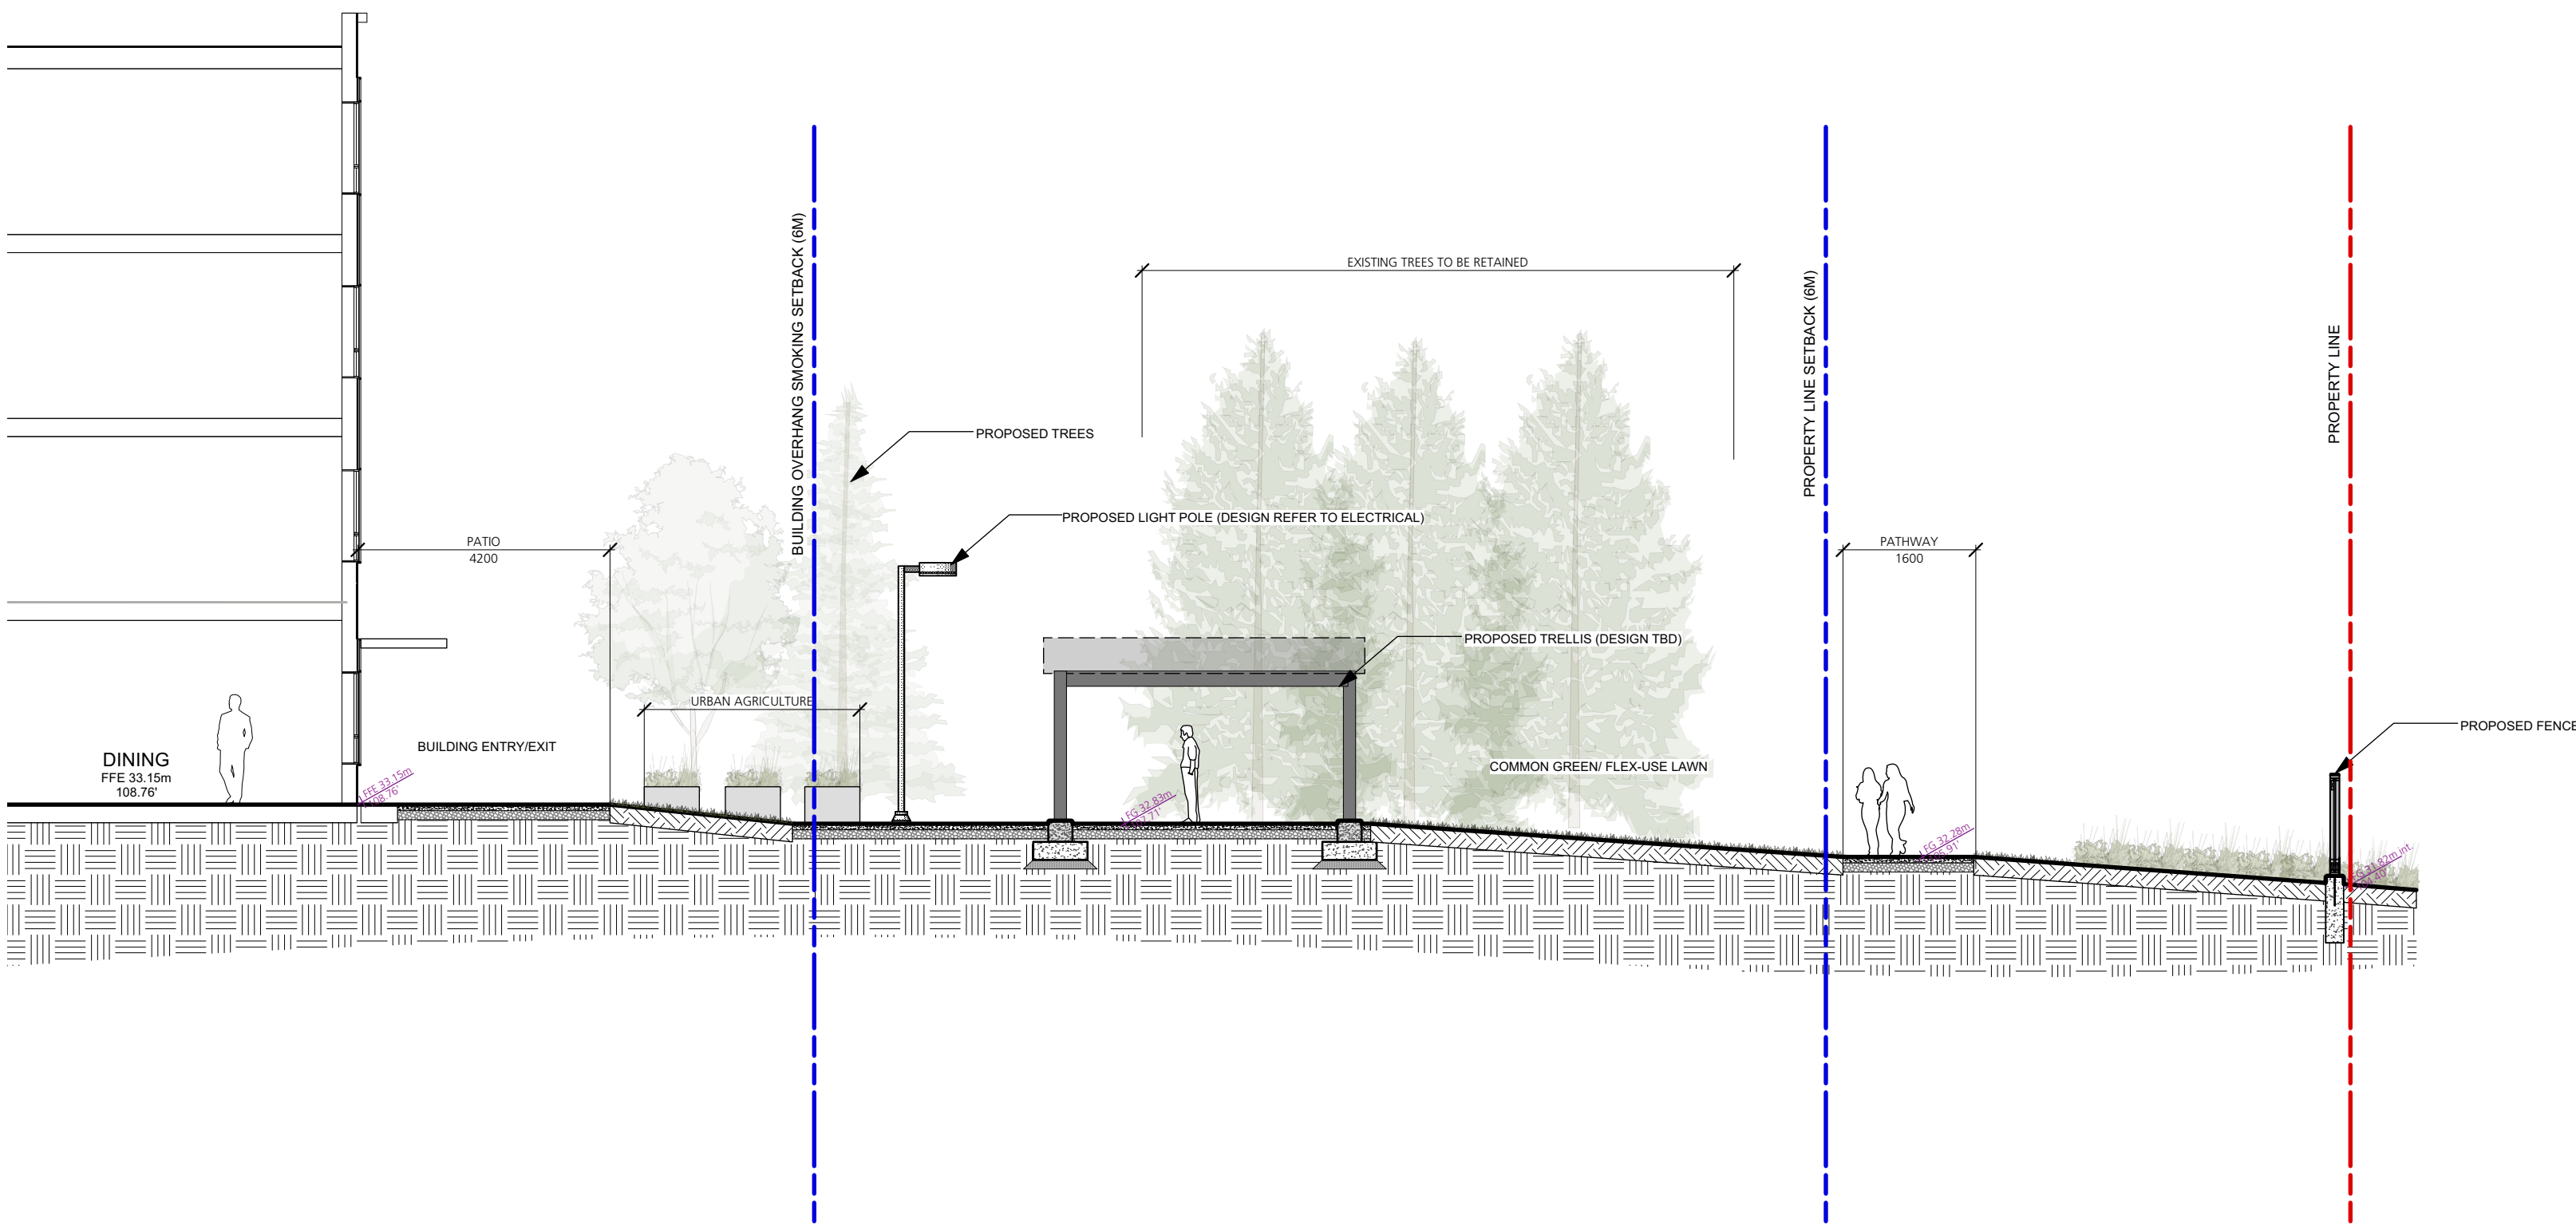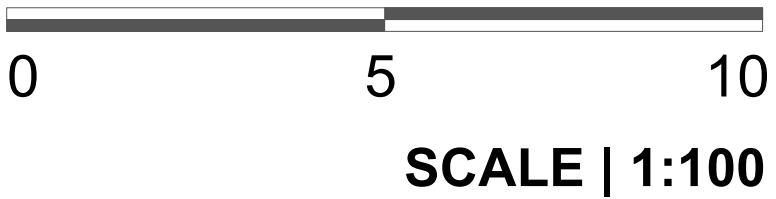

2 South of Building Flex-Use Lawn to Property Line
Scale: 1:100
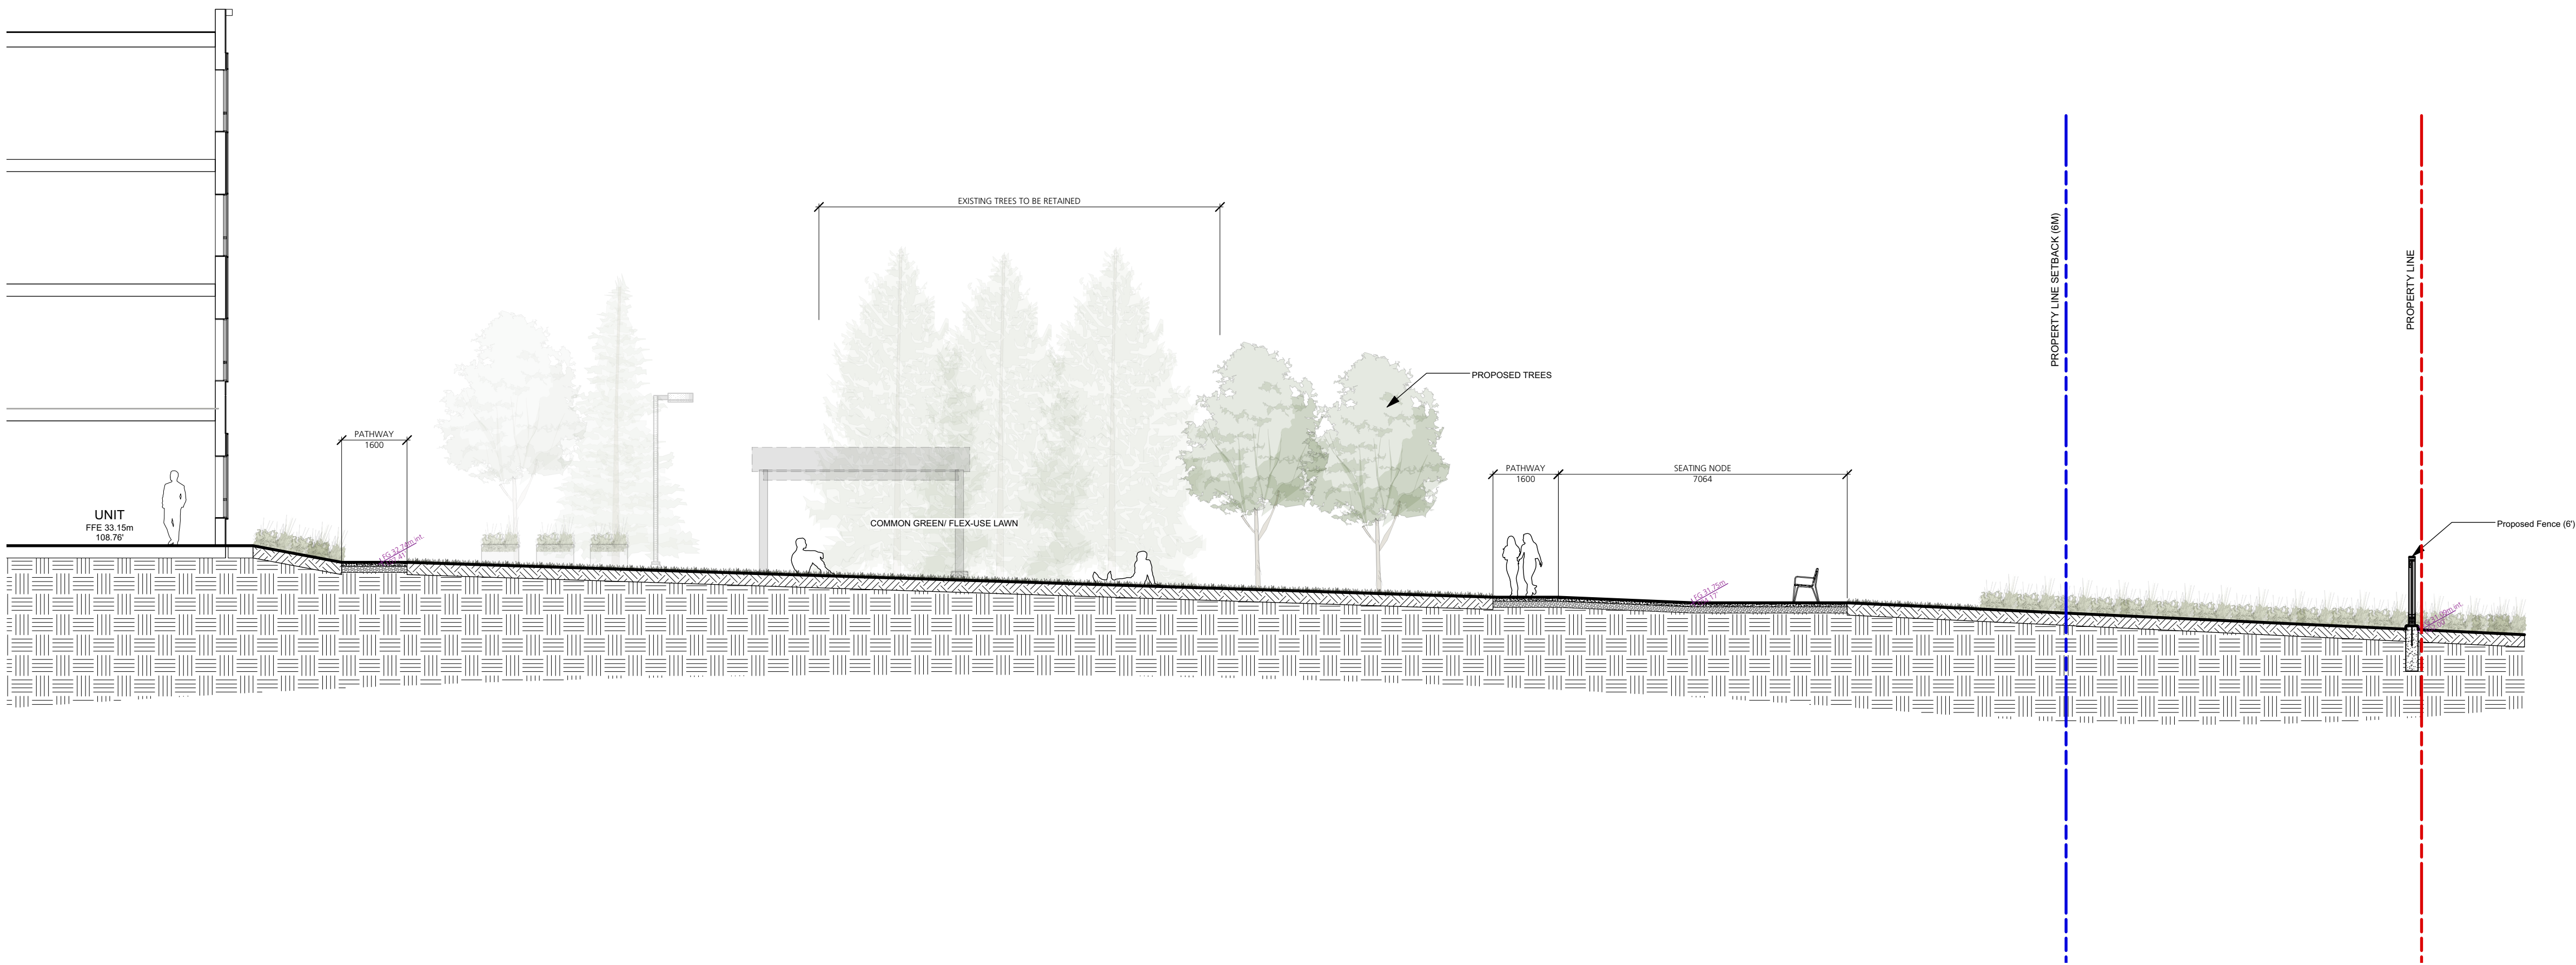
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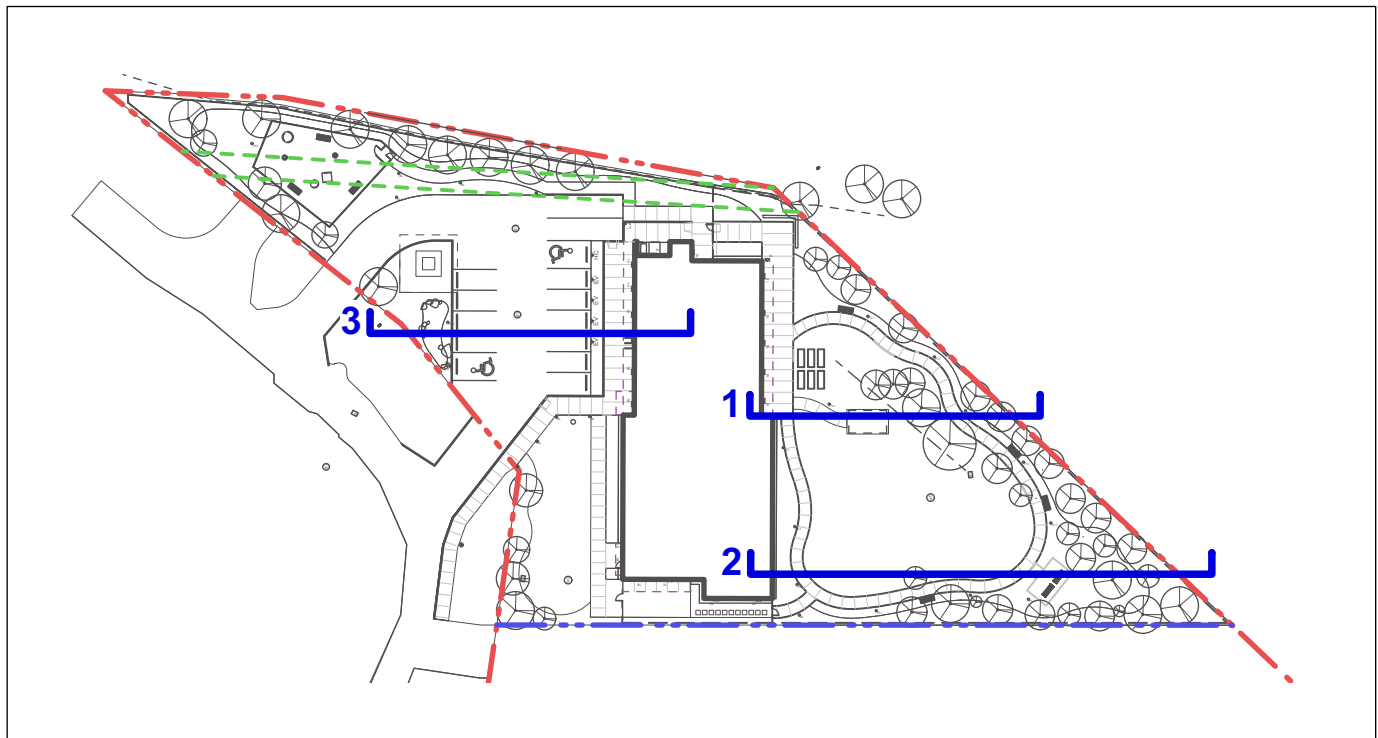
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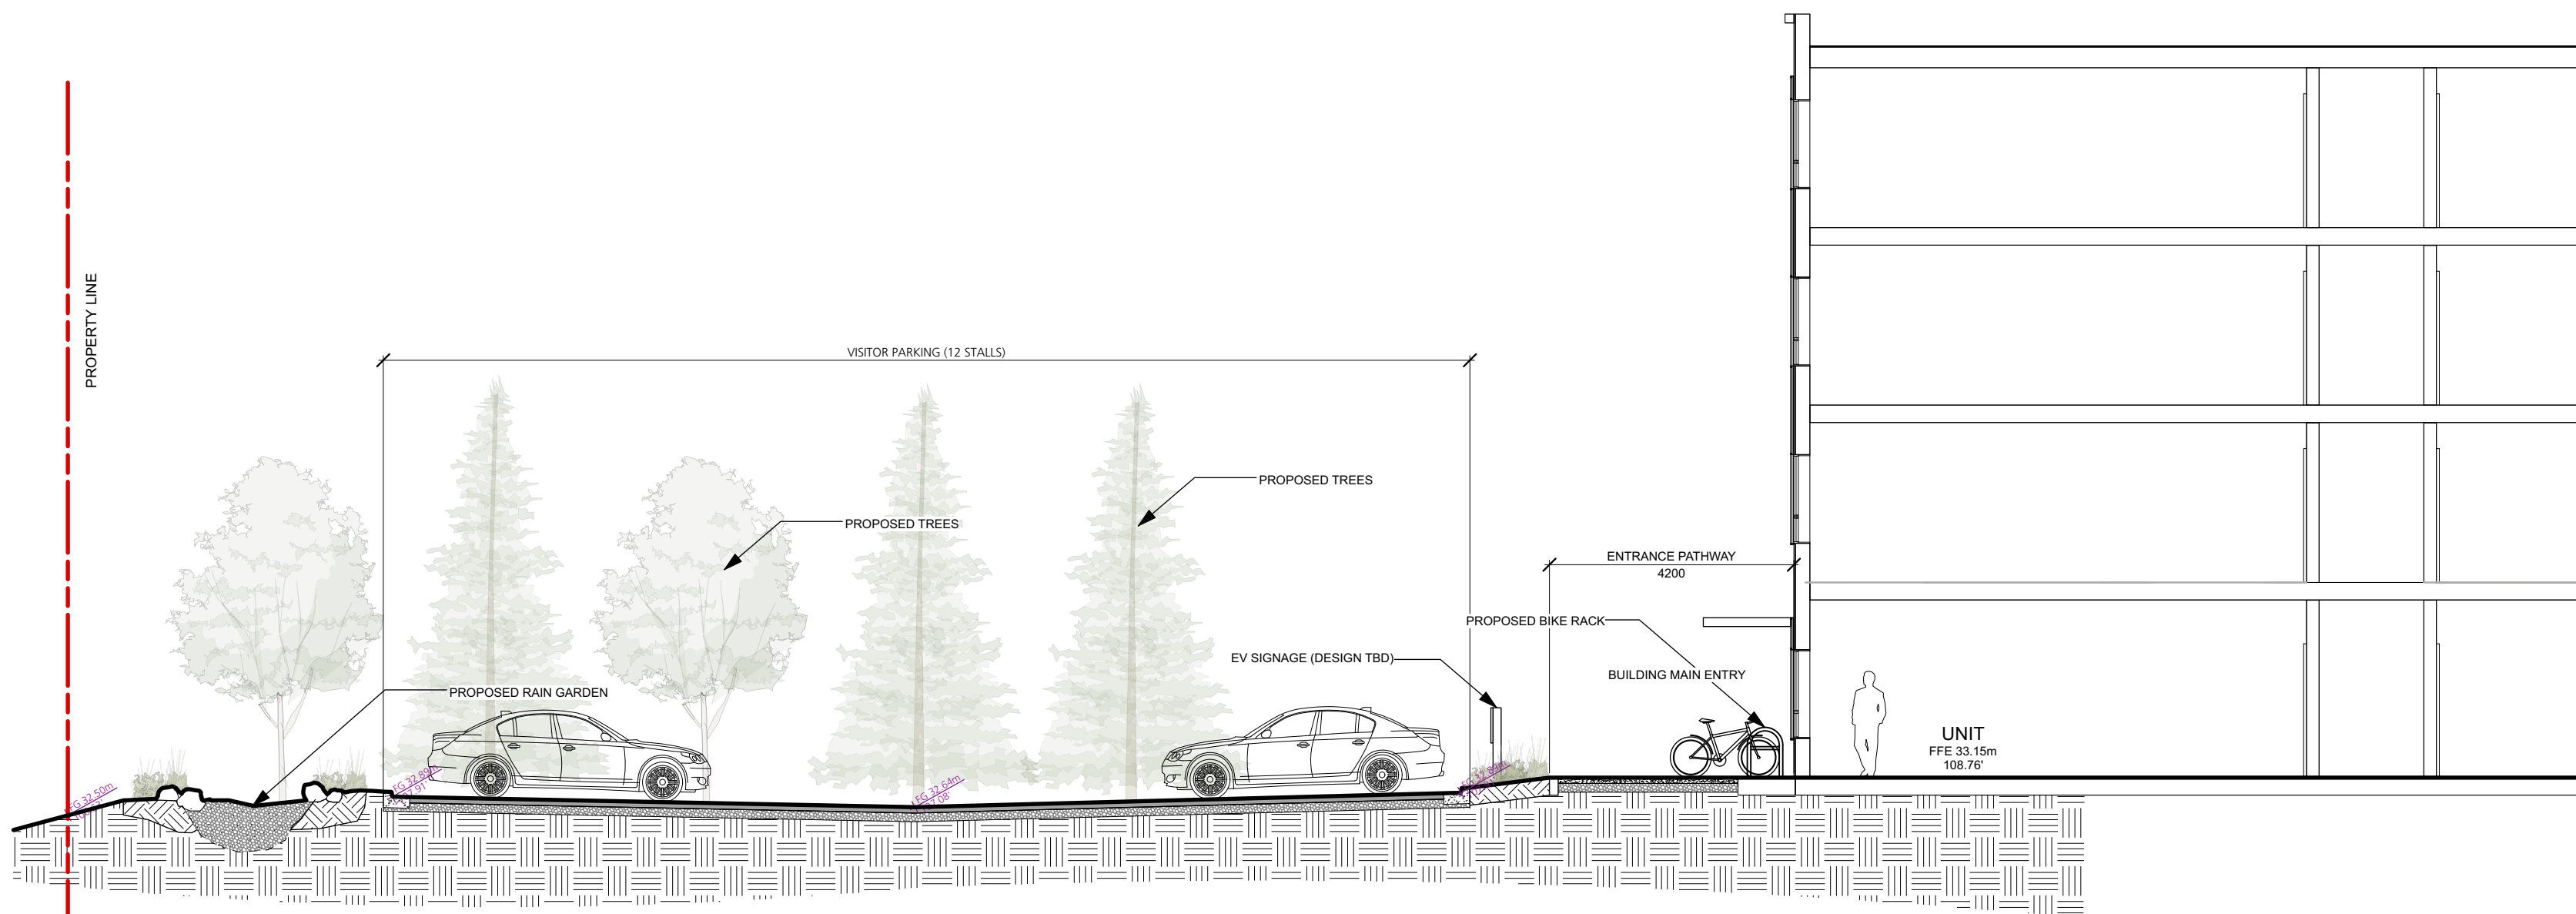
Drawing Title:
**Illustrative Landscape
Sections**

Project North: Drawn By: LR
Checked By: MP
Scale: 1:100 Job No.: 24-038
Sheet No.:

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SECTION KEY PLAN | 1:1000



3 North Parking Lot Entrance to Building
L5.0 Scale: 1:100

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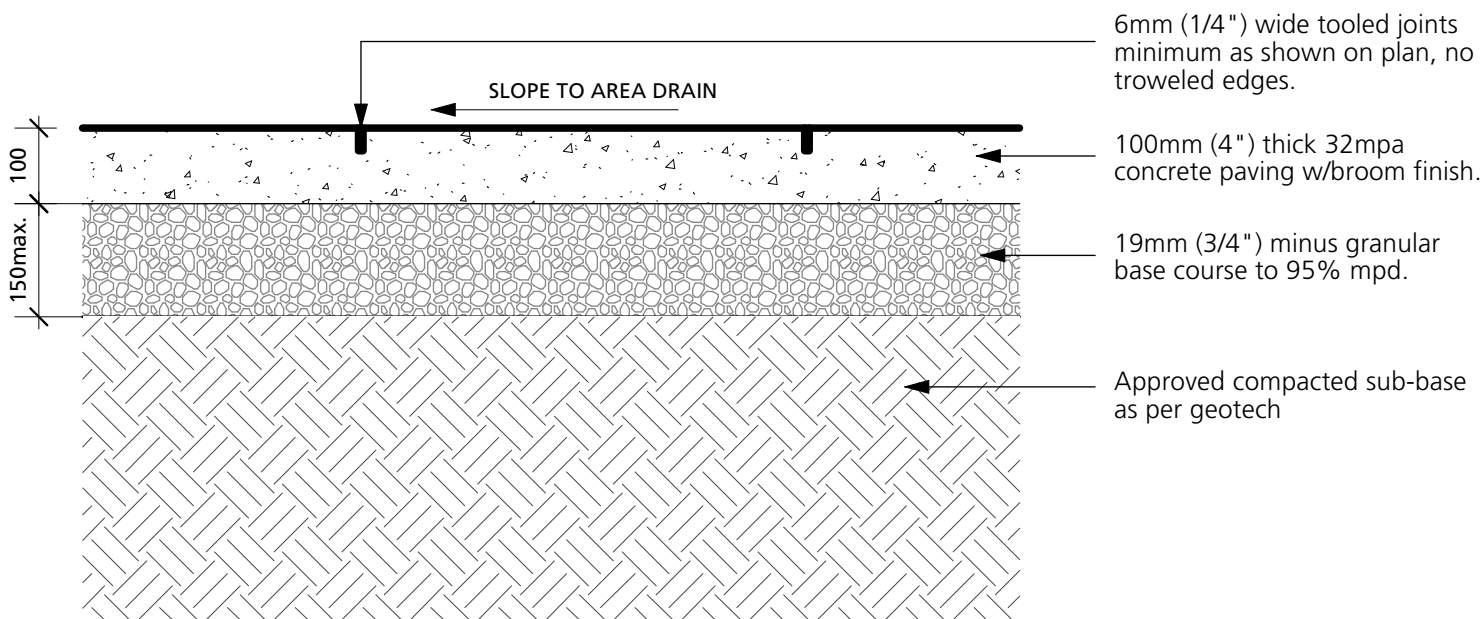
Client: **BC Housing**

Project Title:
1030 Old Victoria Road,
Nanaimo, British Columbia


Drawing Title:
**Illustrative Landscape
Sections**

Project North:	pn 1	Drawn By:	LR
		Checked By:	MP
Scale:	1:100	Job No.:	24-038
Sheet No.:			


Issues No.	Description	Date
1	Issue for 50% DD	2025-04-17
2	Issue for DD	2025-05-14
3	Issue for DD Review/ Resubmission	2025-07-30
4	Issue for Development Permit	2025-08-07




1 C.I.P. Concrete Paving
Scale: 1:10

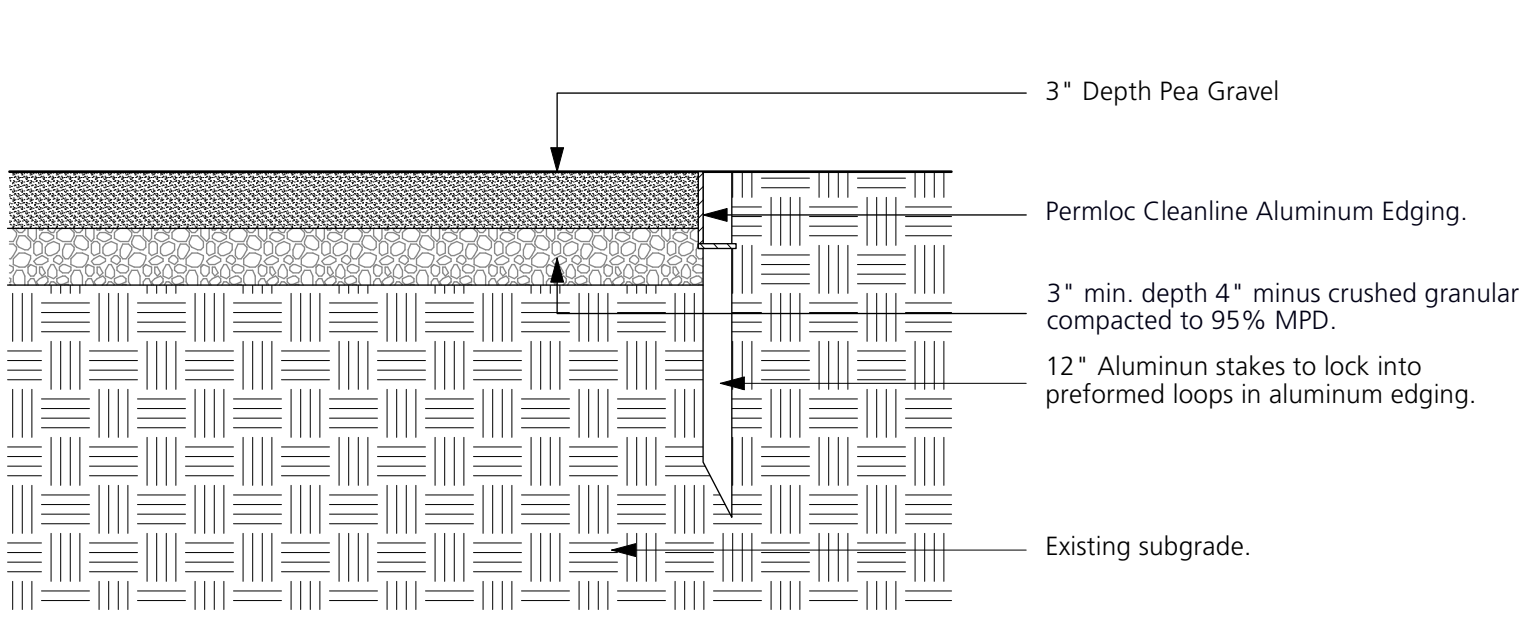


2 Gravel
Scale: 1:10

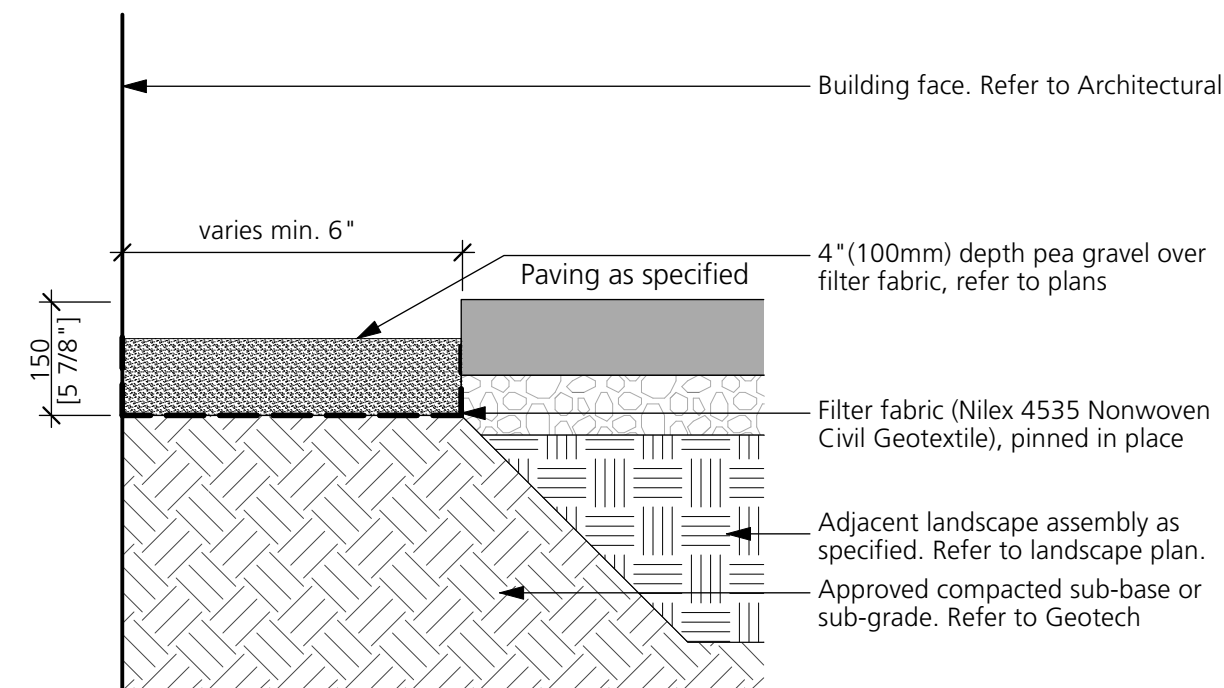

A) GRAVEL STRIP WITH PAVING EDGE

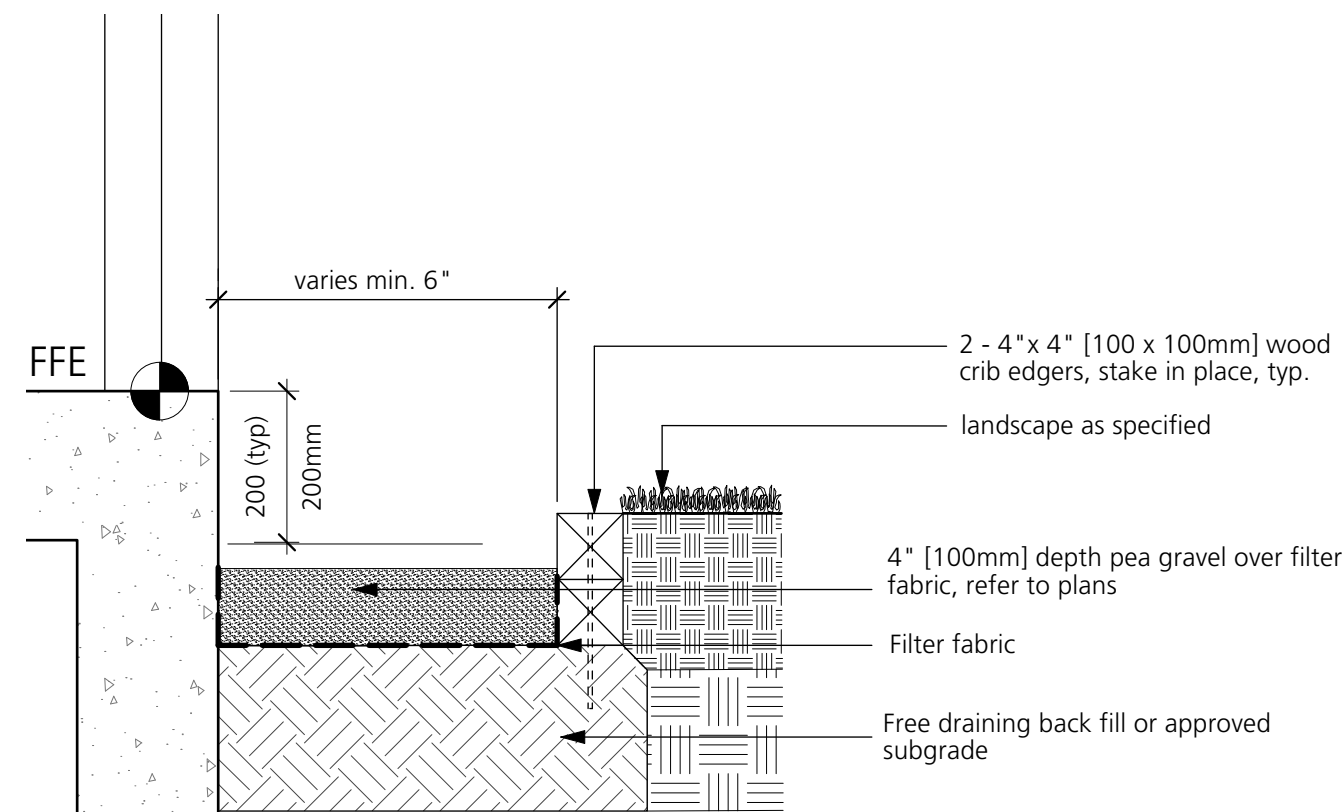


B) GRAVEL STRIP WITH WOOD EDGE

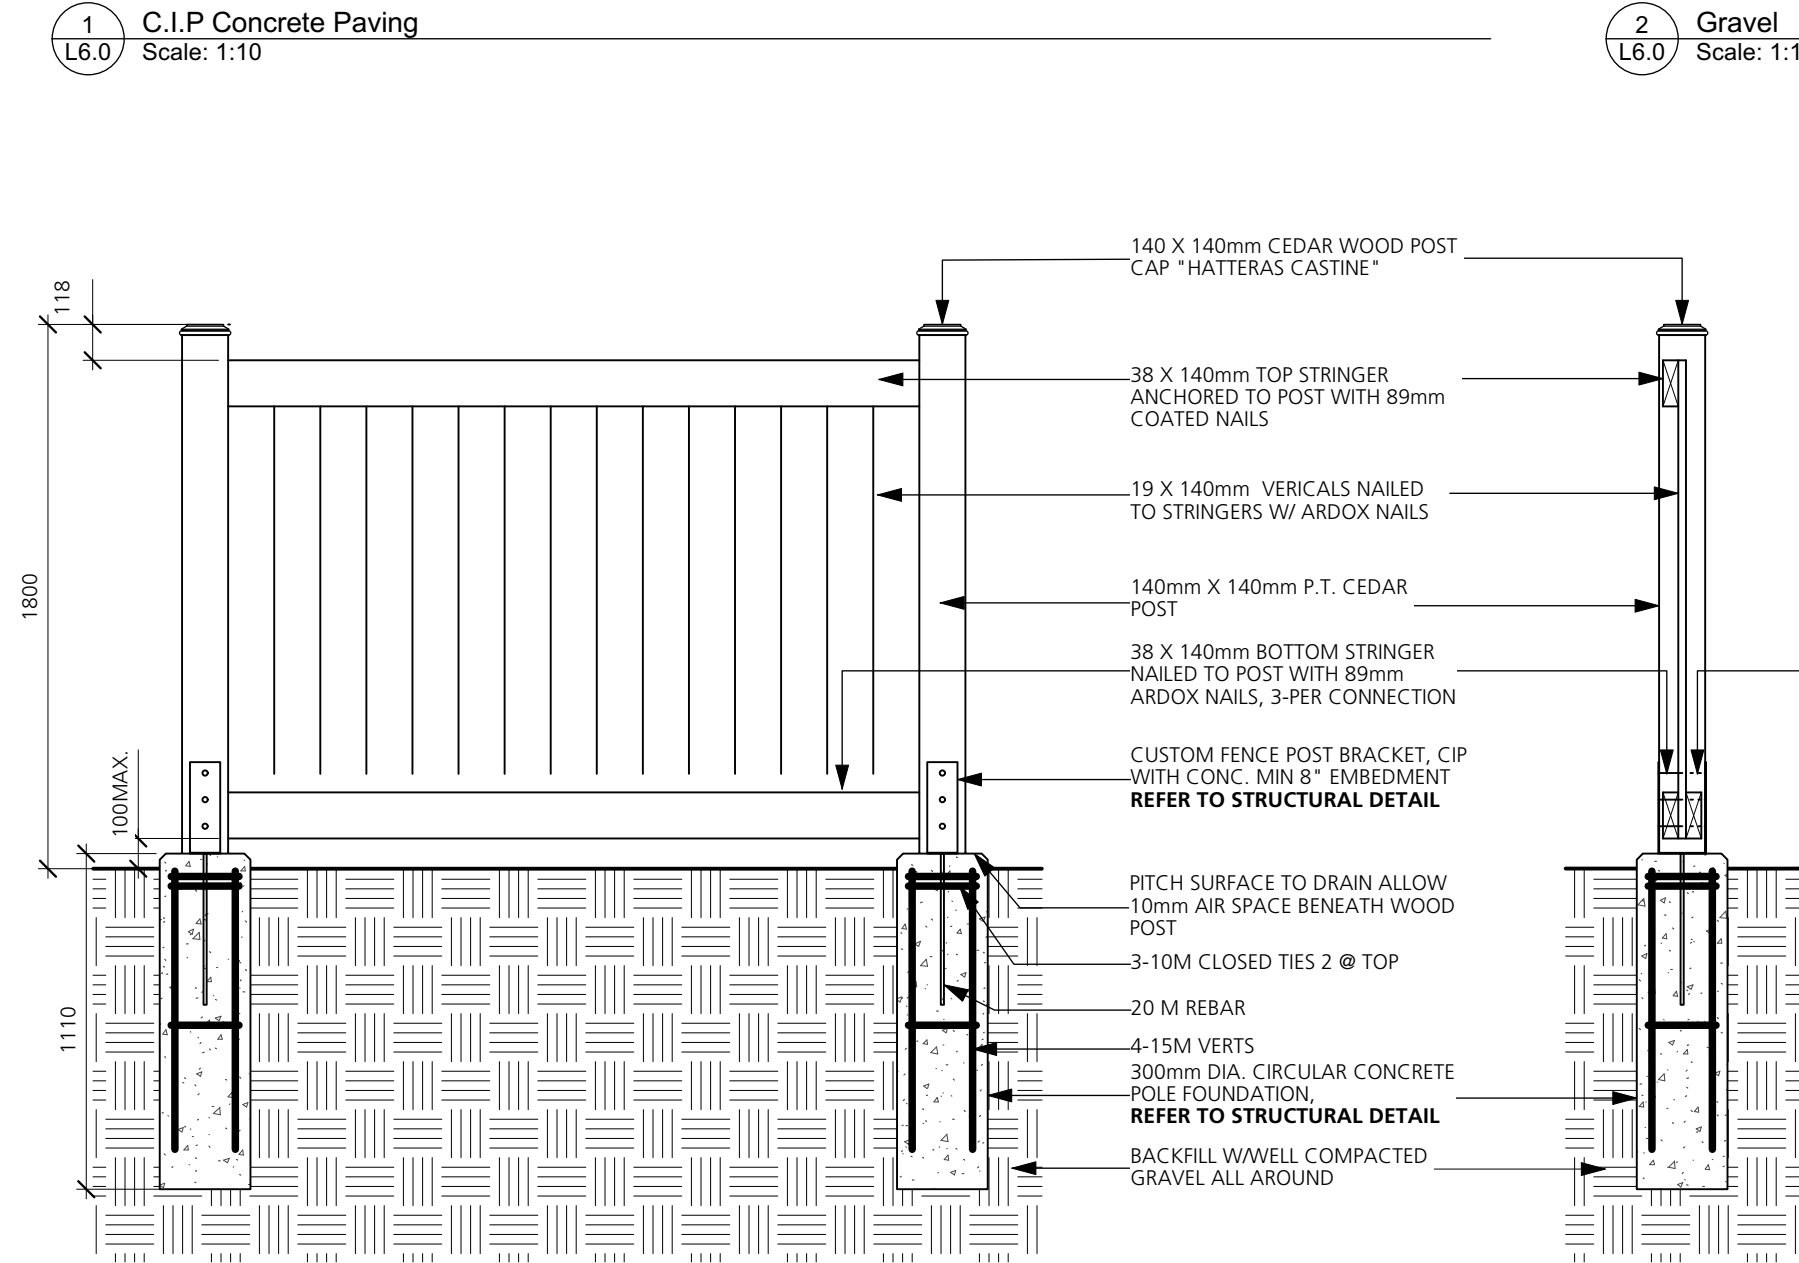


4 6' Wood Fence
Scale: 1:25

- NOTES:
1. ALL WOOD COMPONENTS TO BE SELECT TIGHT KNOTV CEDAR.
 2. CONTRACTOR SHALL SUBMIT SHOP DRAWINGS FOR ALL WOOD COMPONENTS, PRECAST CONCRETE, METAL HARDWARE AND STAINING. CONTRACTORS UNIT PRICE SHALL INCLUDE ALL NECESSARY ADJUSTMENTS AND REVISIONS AS REQUIRED TO OBTAIN OWNER APPROVAL.
 3. ALL CUT MEMBERS TO BE STAINED IN THE FIELD.
 4. FENCING TO BE LOCATED APPROXIMATELY AS PER PLAN. NOTIFY LANDSCAPE ARCHITECT OF ANY DISCREPANCIES ENCOUNTERED IN THE FIELD.
 5. ALL FASTENERS TO BE GALVANIZED.
 6. ENSURE POST FOOTINGS ARE NOT SET TOO FAR ABOVE FINISHED GRADE.
 7. ALL WOOD TO BE STAINED WITH 2 COATS OF SIKKENS EXTERIOR SOLID STAIN
 8. CEDAR WOOD POST CAP AVAILABLE FROM [HTTP://WWW.DECKORATORS.COM](http://www.deckorators.com)

- NOTES:
1. ALL WOOD COMPONENTS TO BE SELECT TIGHT KNOT CEDAR.
 2. CONTRACTOR SHALL SUBMIT SHOP DRAWING FOR ALL WOOD COMPONENTS, PRECAST CONCRETE, METAL HARDWARE AND STAINING FOR APPROVAL. CONTRACTORS UNIT PRICE SHALL INCLUDE ALL NECESSARY ADJUSTMENTS AND REVISIONS AS REQUIRED TO OBTAIN OWNER APPROVAL.
 3. ALL CUT MEMBERS TO BE STAINED IN THE FIELD.
 4. FENCING TO BE LOCATED APPROXIMATELY AS PER PLAN. NOTIFY LANDSCAPE ARCHITECT OF ANY DISCREPANCY'S ENCOUNTERED IN THE FIELD.
 5. ALL FASTENERS TO BE GALVANIZED.
 6. POST FOOTINGS TO BE SET 2" (50mm) ABOVE SOD GRADE
 7. ALL WOOD TO BE STAINED WITH 2 COATS OF SIKKENS EXTERIOR SOLID STAIN
 8. CEDAR WOOD POST CAP AVAILABLE FROM [HTTP://WWW.DECKORATORS.COM](http://www.deckorators.com)

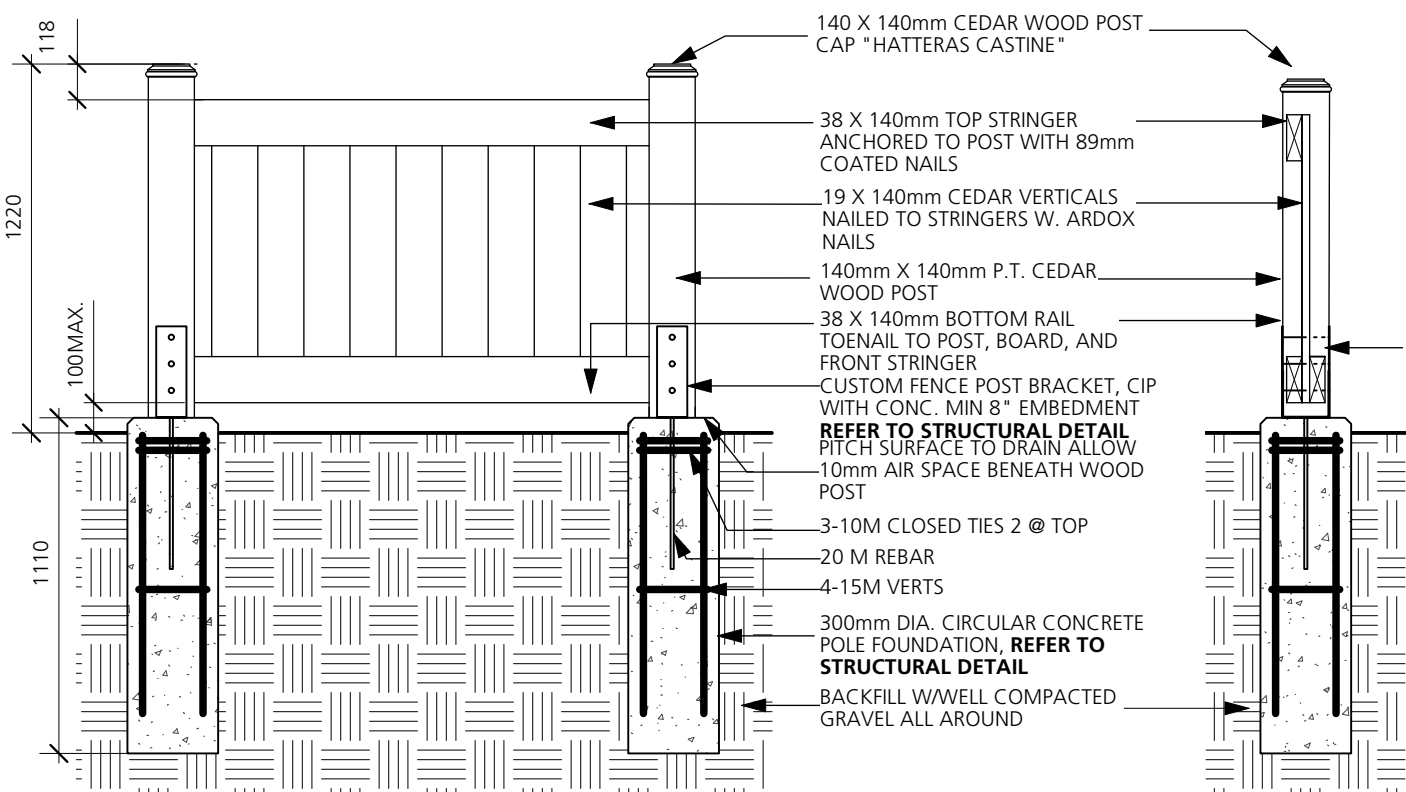


5 4' Wood Fence
Scale: 1:25

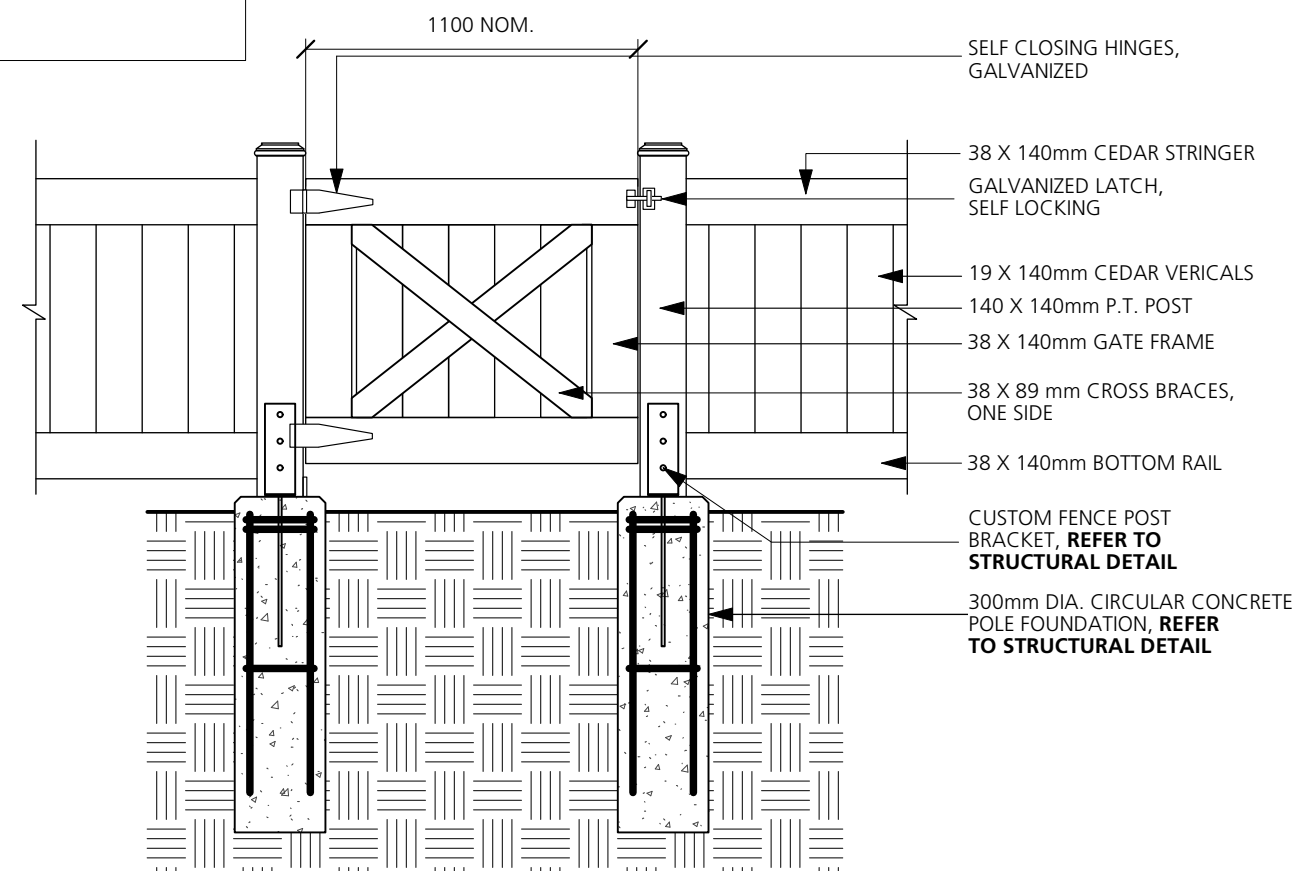


- NOTE:
1. CONTRACTOR TO SUBMIT MAINTENANCE GATE SHOP DRAWING TO INCLUDE ALL WOOD COMPONENTS, PRECAST CONCRETE, METAL HARDWARE INCLUDING HINGES AND SELF LOCKING GARDEN LATCH FOR LANDSCAPE ARCHITECT APPROVAL.

Product: Iconic Bench, IPE Wood with End Arms
Qty: 4
Material: Ipe wood and prefinished anodized cast aluminum
Finishes: Provide standard manufacturer finishes for both Ipe wood and aluminum. Aluminum to be powdercoated.
Installation: Surface mount to concrete slab, bolted into place with tamperproof bolts. Refer to manufacturer's specifications.


Available at **Maglin Site Furniture Inc.**
Contact: <http://www.maglin.com/>
Tel: 1 (800) 716-5506

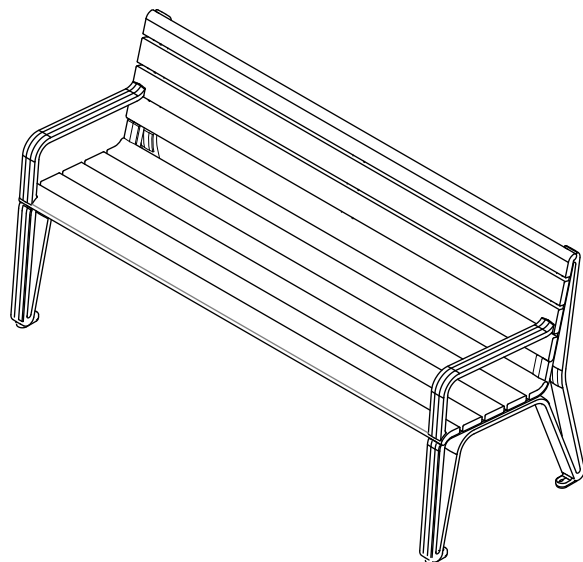

FRONT ELEVATION

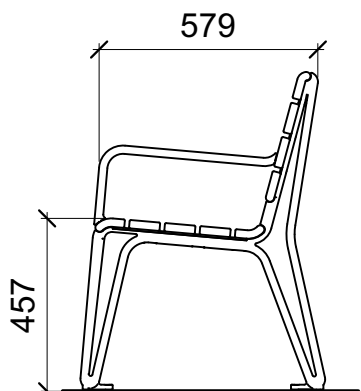

SIDE ELEVATION

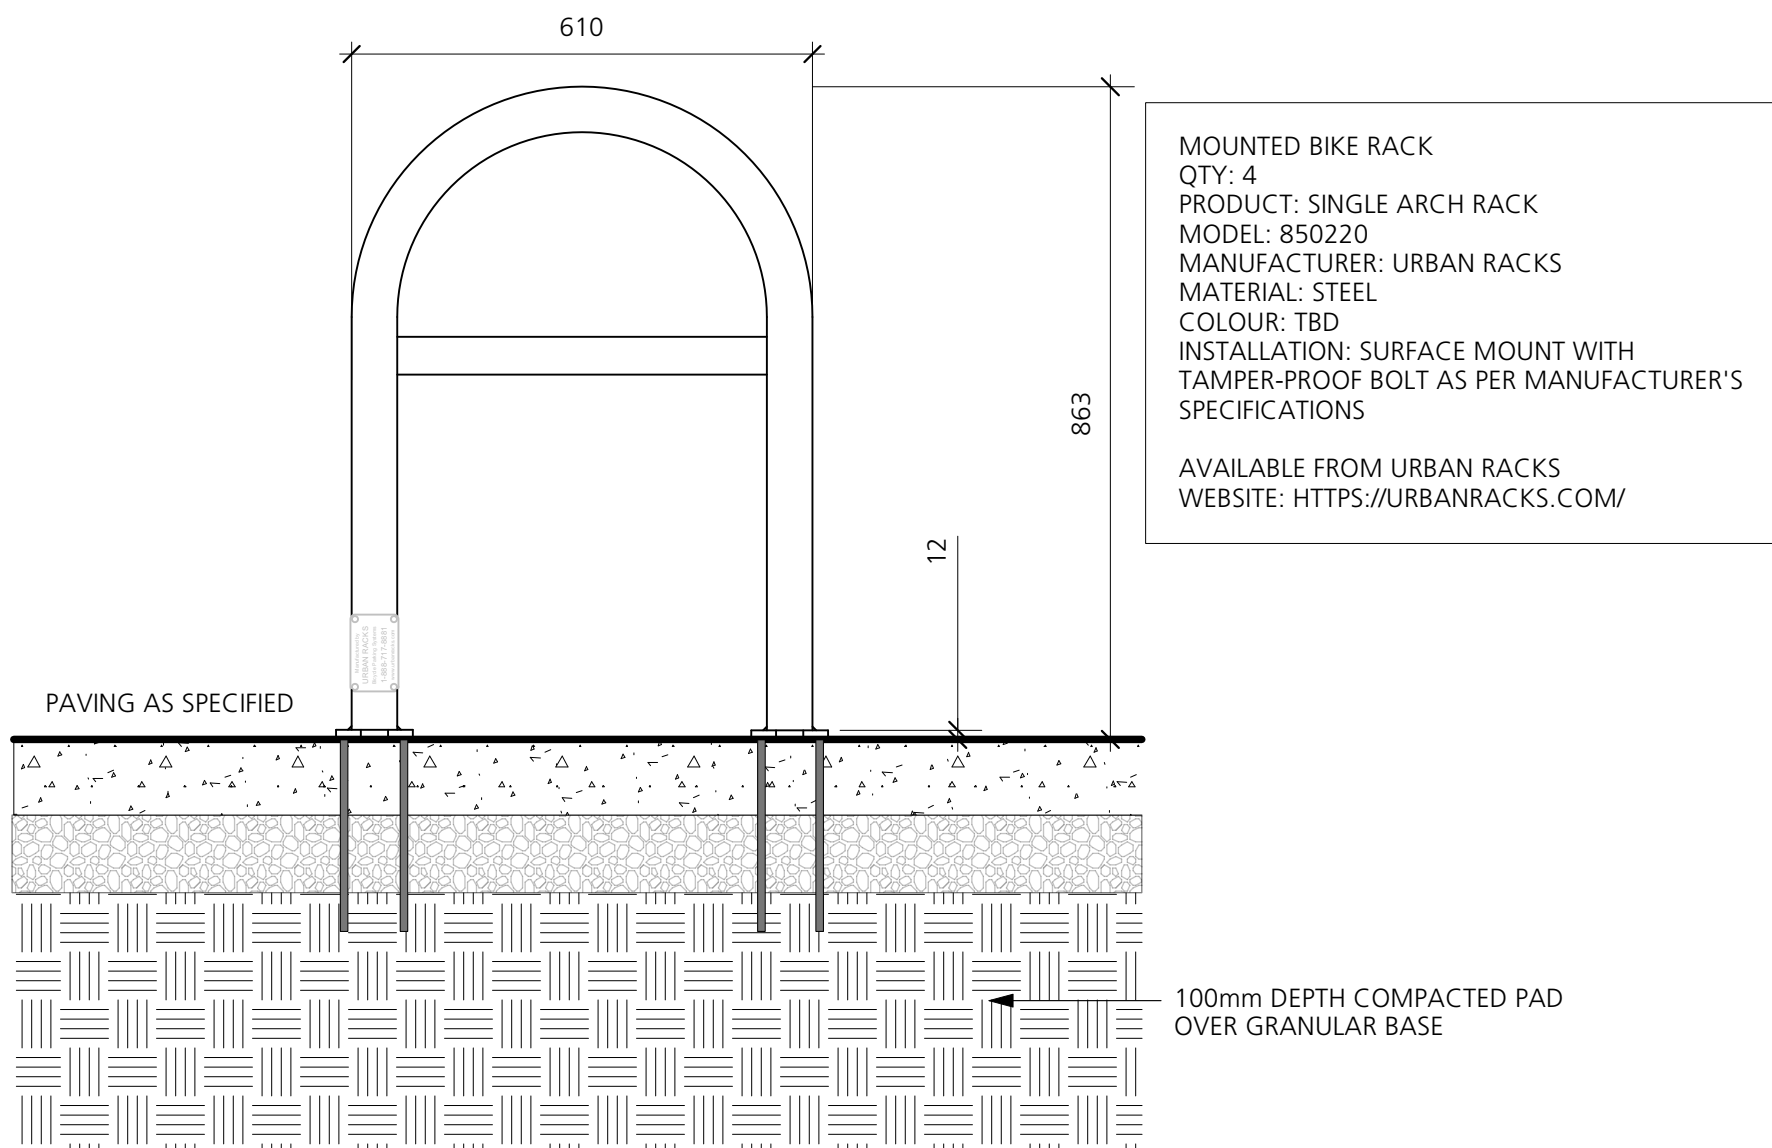

MOUNTED BIKE RACK
QTY: 4
PRODUCT: SINGLE ARCH RACK
MODEL: 850220
MANUFACTURER: URBAN RACKS
MATERIAL: STEEL
COLOUR: TBD
INSTALLATION: SURFACE MOUNT WITH TAMPER-PROOF BOLT AS PER MANUFACTURER'S SPECIFICATIONS
AVAILABLE FROM URBAN RACKS
WEBSITE: [HTTPS://URBANRACKS.COM/](https://urbanracks.com/)


Lit Bollard c/w 360-degree distribution
Model: Refer to Electrical
Qty:

- 7 at Building Front Yard
- 1 in Back Amenity Space

Finish: To be confirmed

Note:

- Refer to plan for locations, spacing and orientation.
- All surface mount to be c/w tamper proof bolts per manufacturer's specifications.
- Provide shop drawings for Landscape Architect review and approval.
- Color temperature for LED Lighting to be 3000K and 360° distribution.

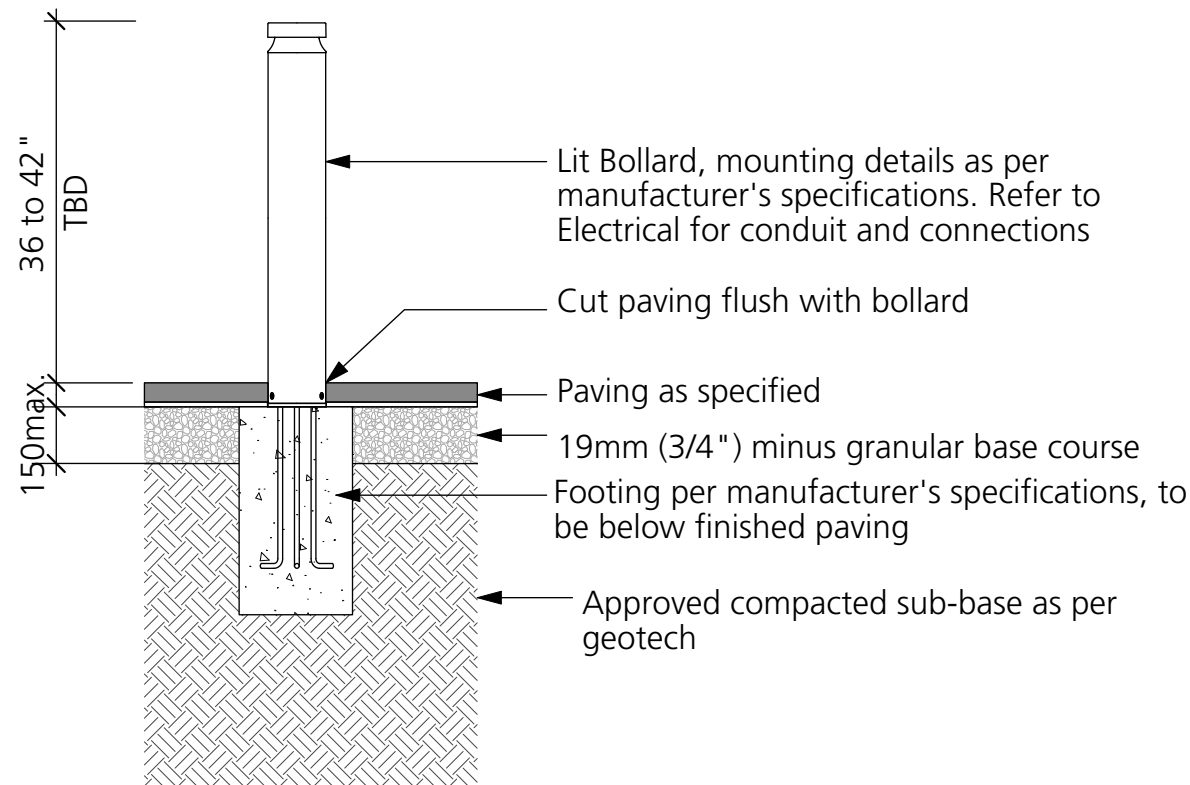

8 Light Bollard
Scale: 1:20

6 Linear Bench
Scale: 1:20

7 Bike Rack
Scale: 1:10

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Client:

BC Housing

Project Title:

1030 Old Victoria Road,
Nanaimo, British Columbia


Drawing Title:

Landscape Details

Project North:	pn	Drawn By:	LR
		Checked By:	MP
Scale:		Job No.:	24-038
Sheet No.:			

Issues		
No.	Description	Date
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- Note:**
- Do not cut leader.
 - Protect tree from danger during planting. Ensure rootball is protected from sun, frost or dessication.
 - Tree selection, handling, planting and maintenance must meet BCSLA/BCUNA standards, be in good health and condition without wounds, have normal form, and be free of diseases and pests.
 - Site preparation must include provision for soil placement, replacement or enhancement to meet project specifications.
 - Planting holes must be free draining to the extent that rainwater and/or supplemental water does not accumulate and drown the roots. If necessary, the subgrade must be graded with positive slope and/or drainage services must be installed to suit.
 - Watering of the root ball must be undertaken immediately after planting and then for the first growing season so that the root ball is thoroughly wetted once per week (minimum).
 - The mulched root zone should be refreshed annually to replace the mulch. This area must be weeded by hand to avoid trunk and root damage from string trimmers or mowers.
 - The tree should be pruned to ANSI A3000 standards after establishment and from time to time to train it for structure to conform to the form of the species and to respond to growing site constraints. All pruning must be undertaken by or performed under the direction of a qualified arborist certified by the International Society of Arboriculture and who demonstrates proficiency in pruning.

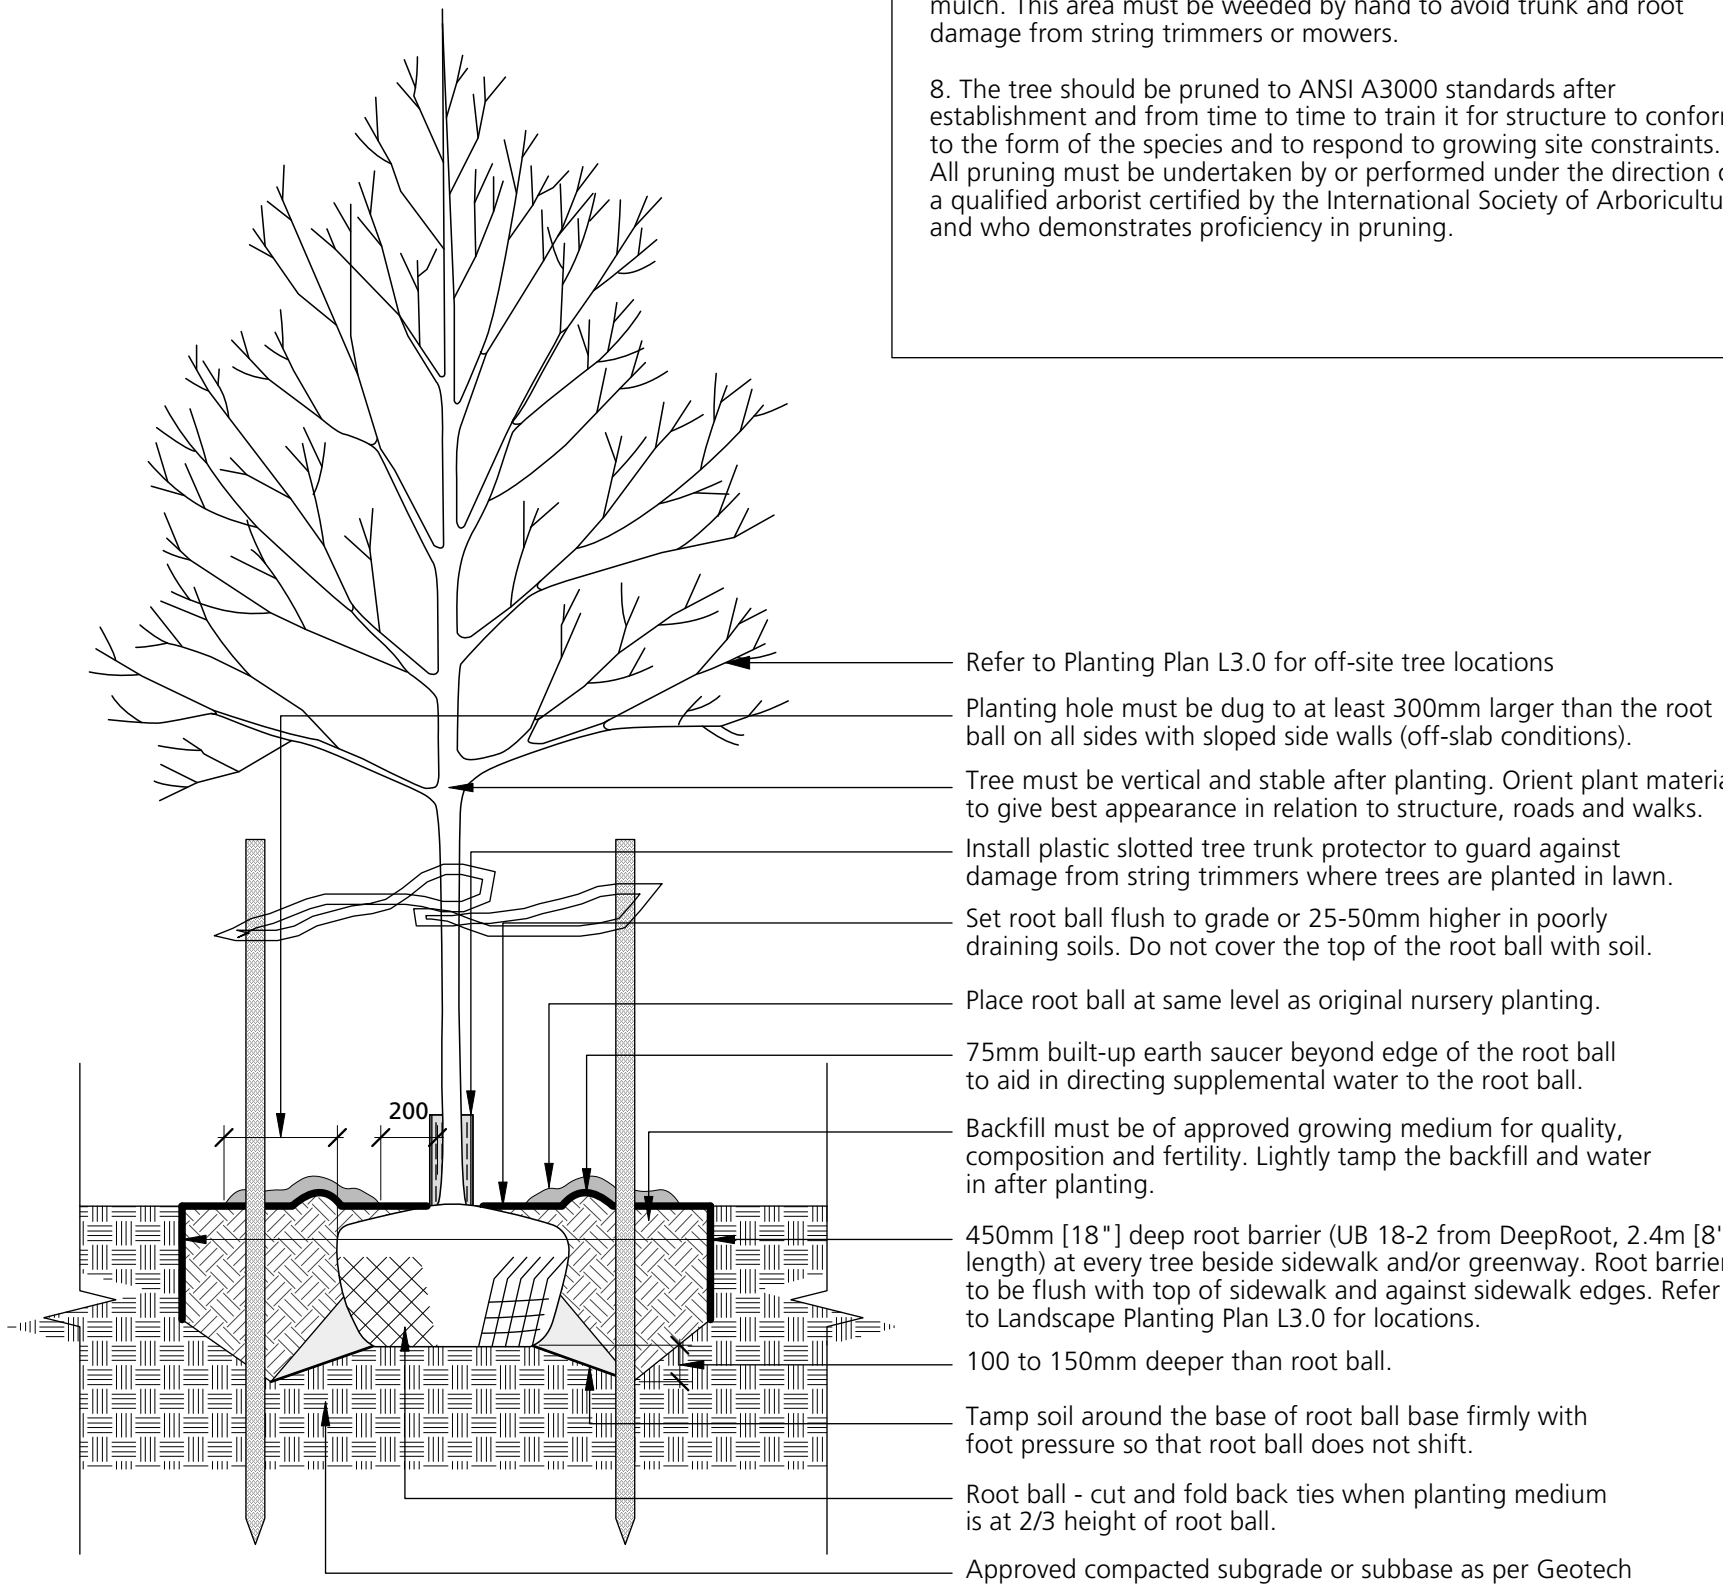

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Client:

BC Housing

Project Title:

1030 Old Victoria Road,
Nanaimo, British Columbia

Drawing Title:

Landscape Details

Project North: PN


Drawn By: LR

Checked By: MP

Scale: Job No.: 24-038


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L6.1

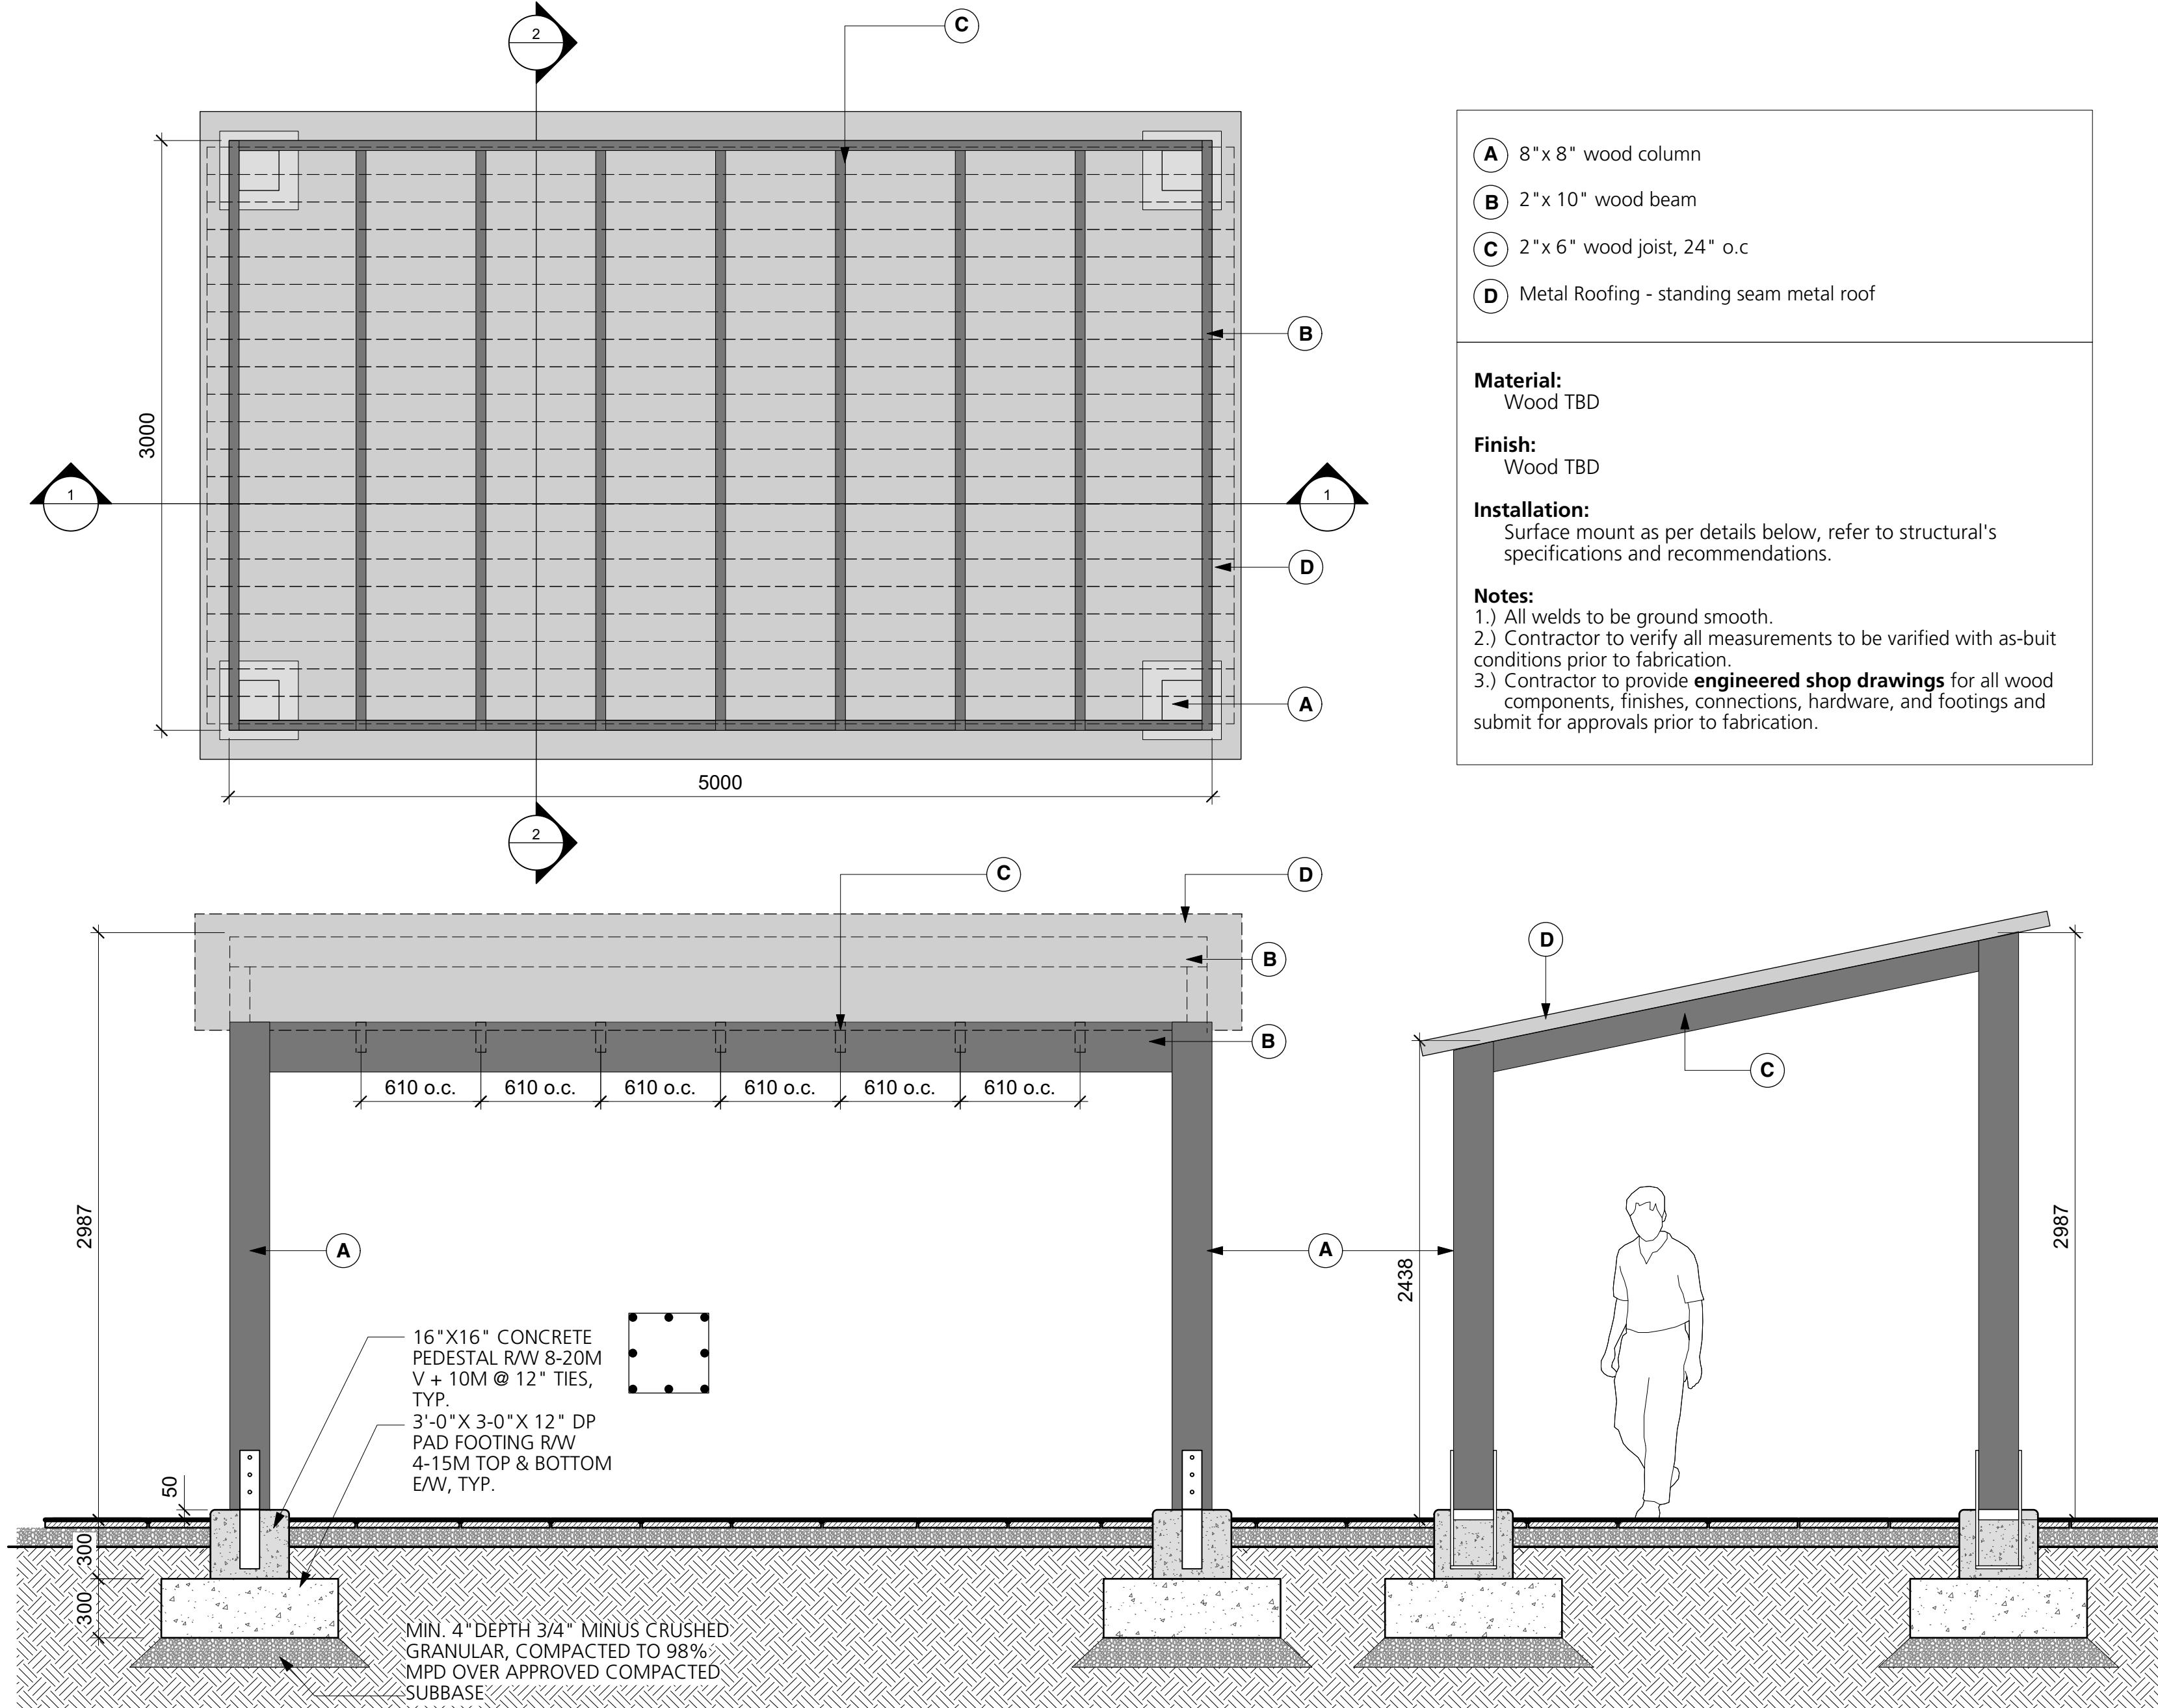


1 Pavilion
Scale: 1:25

- Note:**
- Min. root spread to be in accordance with "american standards for nursery stock."
 - For container-grown shrubs, use fingers or small hand tools to pull the roots out of the outer layer of potting soil; then cut or pull apart any roots that circle the perimeter of the container. prune all damaged, diseased, or weak limbs and roots.
 - Cleanly prune all damaged root ends.
 - Fold burlap from top of root ball down into ground set top of ball flush with finish grade.
 - Do not allow roots to dry out during installation process.
 - Soak roots in water overnight before planting.

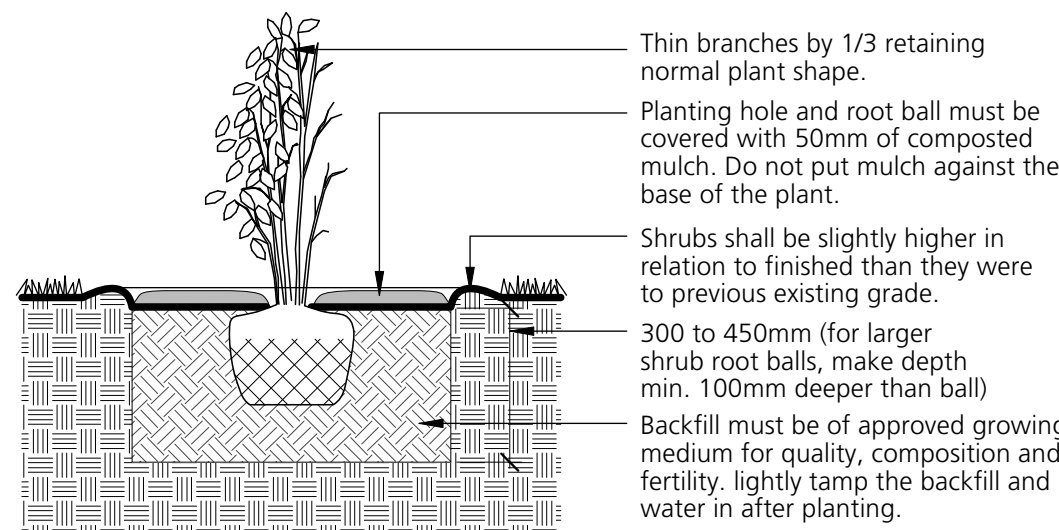

3 Shrub Planting
Scale: 1:20

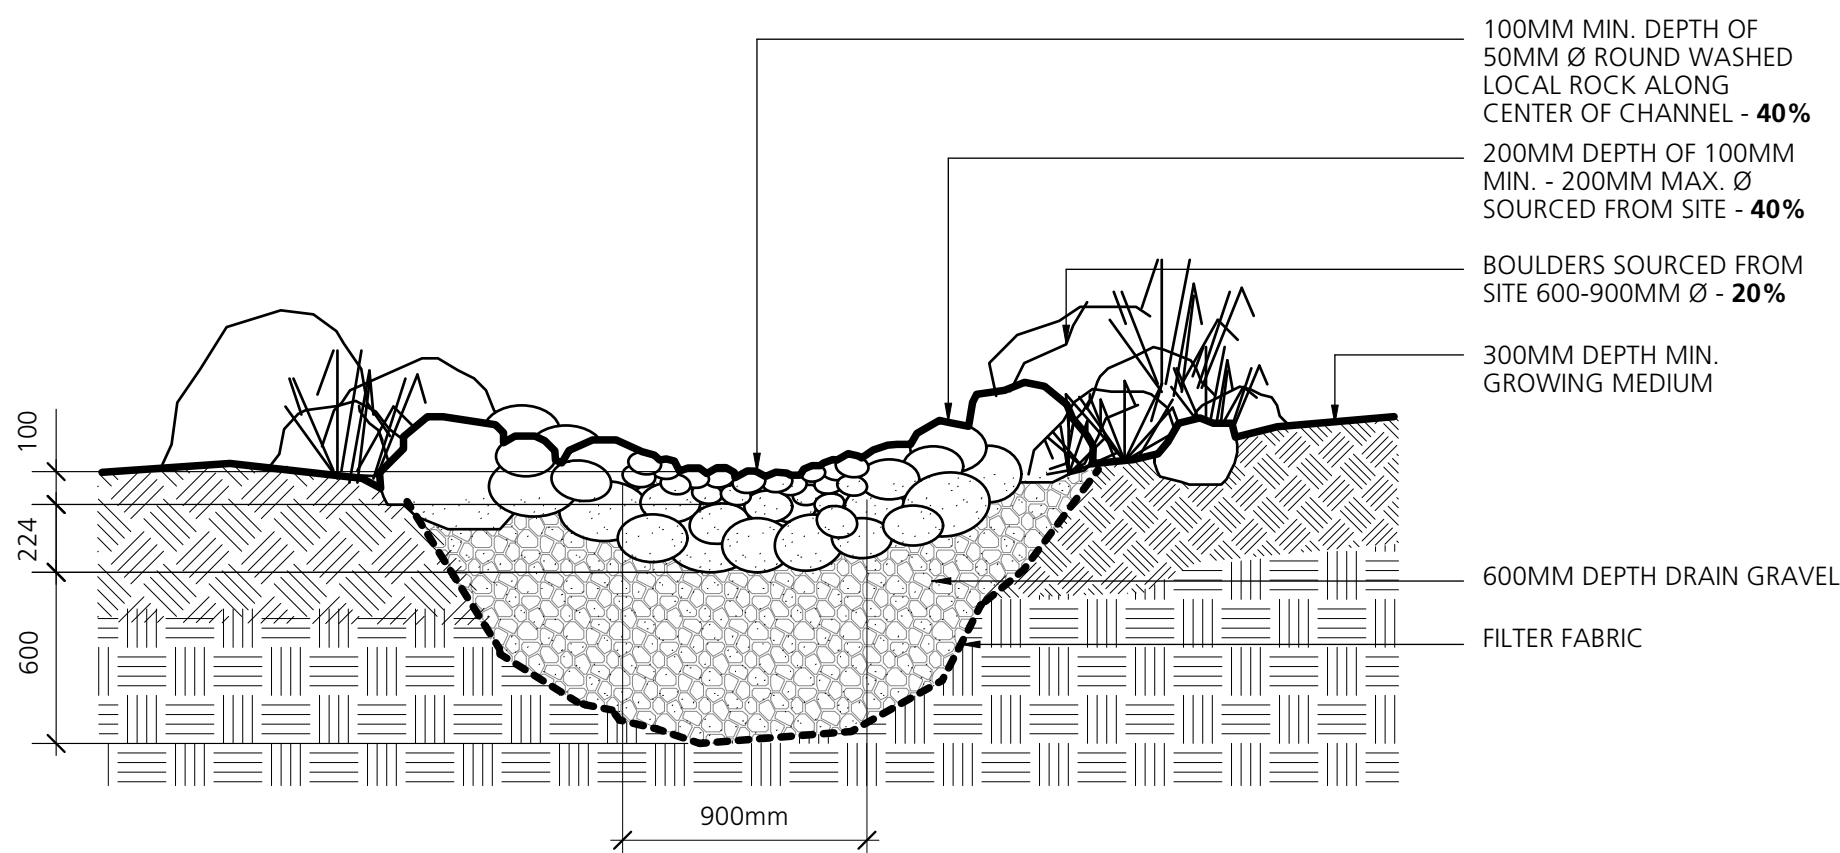


4 Rain Garden
Scale: 1:25

2 Tree Planting
Scale: 1:20

5 Lawn Planting
Scale: 1:10

Model: MCCH720-M
Manufacturer: Maglin
Colour: TBD
Qty: 3

Material: Metal
Finishes: Provide Maglin standard finishes for both ipe wood and steel. Steel to be powdercoat Gunmetal (gloss finish).
Installation: Surface mount, bolted into place with tamper proof bolts. Refer to manufacturer's specifications.

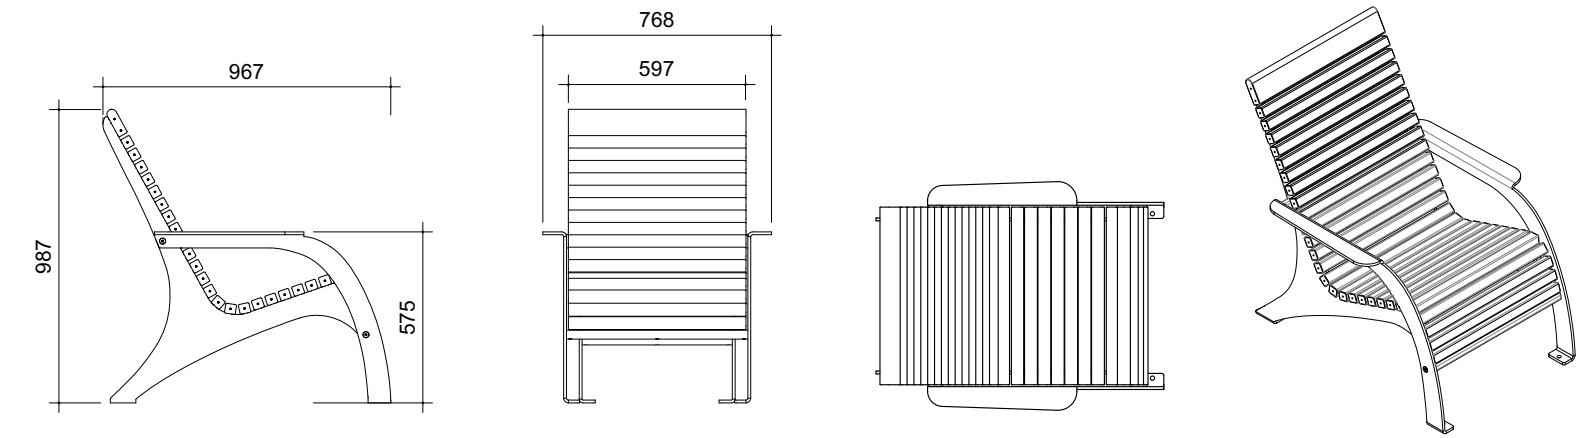

1
L6.2

Lounger

Scale: 1:25

pld date: 2025-08-07

P+A

Perry + Associates
Landscape Architecture
Site Planning

112 East Broadway
Vancouver, BC V5T 1V9
T: 604.738.4118
perryandassociates.ca

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Client:

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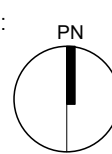
Project Title:

1030 Old Victoria Road,
Nanaimo, British Columbia

Drawing Title:

Landscape Details

Project North:



Drawn By:

LR

Checked By:

MP

Scale:

Job No.:

24-038

Sheet No.:

L6.2